RESIDENTIAL FLAT BUILDING AT 28 & 30 MCKAY AVENUE MOOREBANK NSW 2170

DRAWING LIST

DRAWING NUMBER	DRAWING NAME
DA-000	COVER PAGE
DA-001	
DA-100	MASSING STUDY
DA-200	SITE-ROOF PLAN
DA-201	BASEMENT LEVEL 01 PLAN
DA-202	BASEMENT LEVEL 02 PLAN
DA-203	GROUND FLOOR PLAN
DA-204	LEVEL 01 FLOOR PLAN
DA-205	LEVEL 02 FLOOR PLAN
DA-206	LEVEL 03 FLOOR PLAN
DA-207	LEVEL 04 FLOOR PLAN
DA-208	LEVEL 05 FLOOR PLAN
DA-209	LEVEL 06 FLOOR PLAN
DA-210	ROOF PLAN
DA-211	DETAILED PLAN - GF LVL
DA-212	DETAILED PLAN - LVL 01
DA-213	DETAILED PLAN - LVL 02
DA-214	DETAILED PLAN - LVL 03
DA-215	DETAILED PLAN - LVL 04
DA-216	DETAILED PLAN - LVL 05
DA-217	DETAILED PLAN - LEVEL 06
DA-218	DETAILED PLAN - ROOF
DA-221	ADAPTABLE UNIT TYPE A PRE ADAPTION
DA-222	ADAPTABLE UNIT TYPE A POST ADAPTION
DA-223	ADAPTABLE UNIT TYPE B PRE ADAPTION
DA-224	ADAPTABLE UNIT TYPE B POST ADAPTION
DA-230	TYPICAL FACADE DETAIL 1 (ROOF)
DA-231	TYPICAL FACADE DETAIL 2 (BALCONY)
DA-300	FRONT ELEVATION-S & EXTERNAL FINISHES SCHEDULE
DA-301	REAR ELEVATION -N
DA-302	SIDE ELEVATION -E
DA-303	SIDE ELEVATION -W
DA-350	SECTIONS
DA-352	RAMP SECTIONS
DA-400	BUILDING HEIGHT PLANE 3D
DA-401	VENTILATION STUDY
DA-402	SOLAR STUDY
DA-403	STORAGE CALCULATIONS
DA-404	GROSS FLOOR AREA CALCULATIONS
DA-405	LANDSCAPE CALCULATIONS
DA-406	DEVELOPMENT CALCULATIONS
DA-407	WINDOW SCHEDULE
DA-500	SHADOW DIAGRAMS STUDY
DA-501	SOLAR ACCESS AT 1 PM - 3 PM



STREETSCAPE VIEW - MCKAY AVENUE 1

\DA-000/ 1:300

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С С


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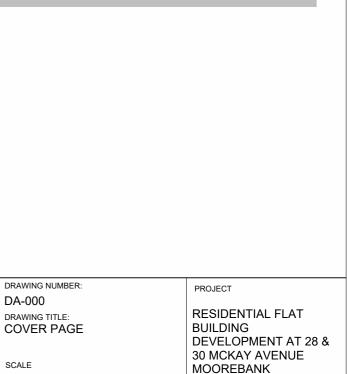
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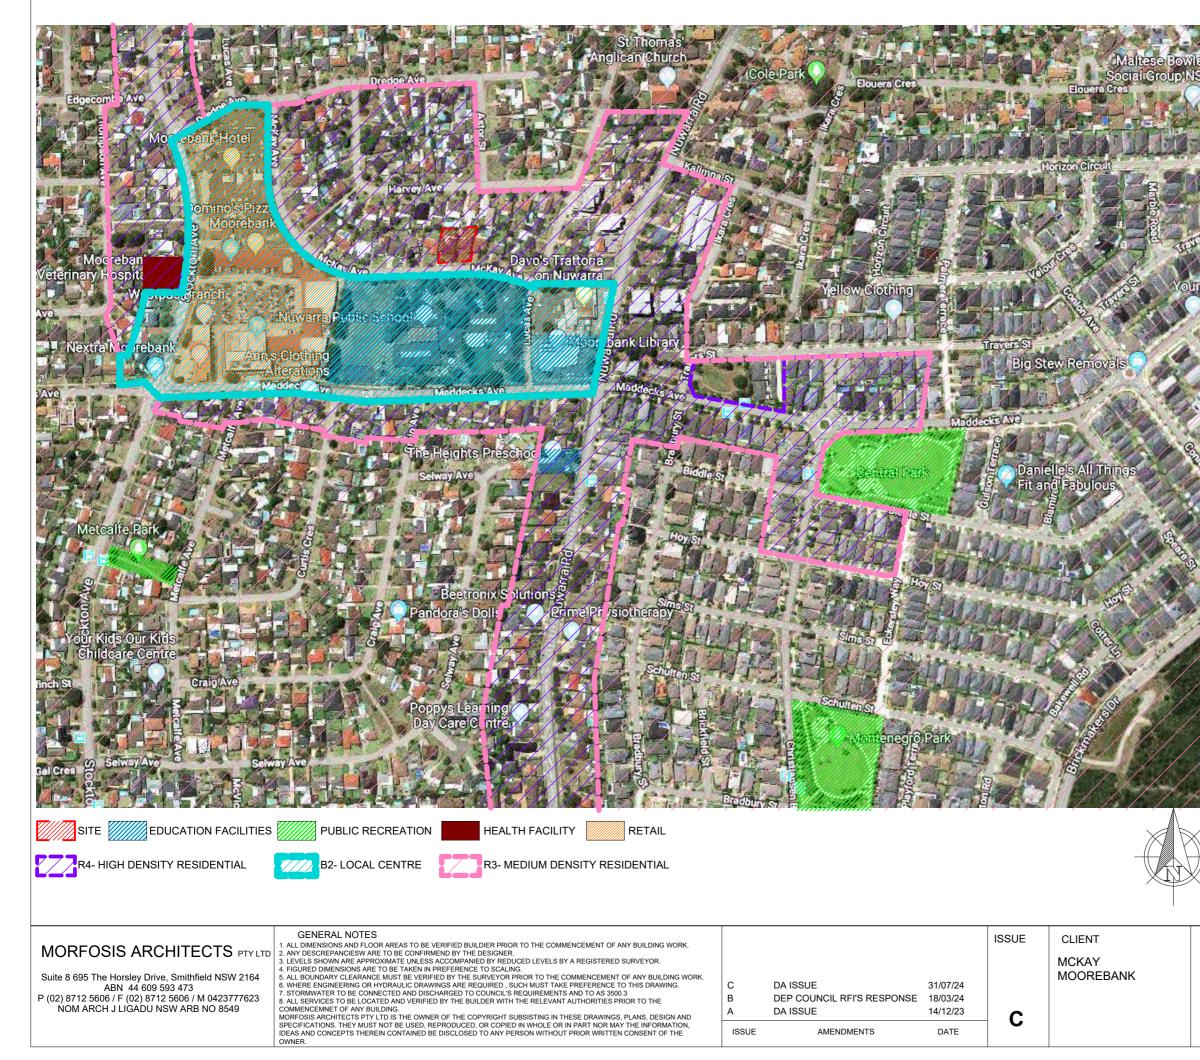
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SCALE 1 : 300 @ A3







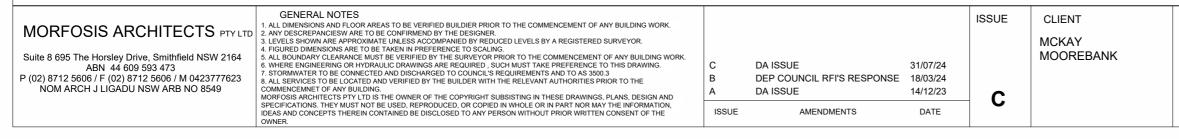

LUCAS AVENUE-STREET VIEW



MCKAY AVENUE-STREET VIEW



MOOREBANK COMMUNITY CENTRE AND LIBRARY




NUWARRA PUBLIC SCHOOL

DRAWING NUMBER: DA-001 DRAWING TITLE: LOCATION MAP

SCALE

1 : 300 @ A3

PROJECT

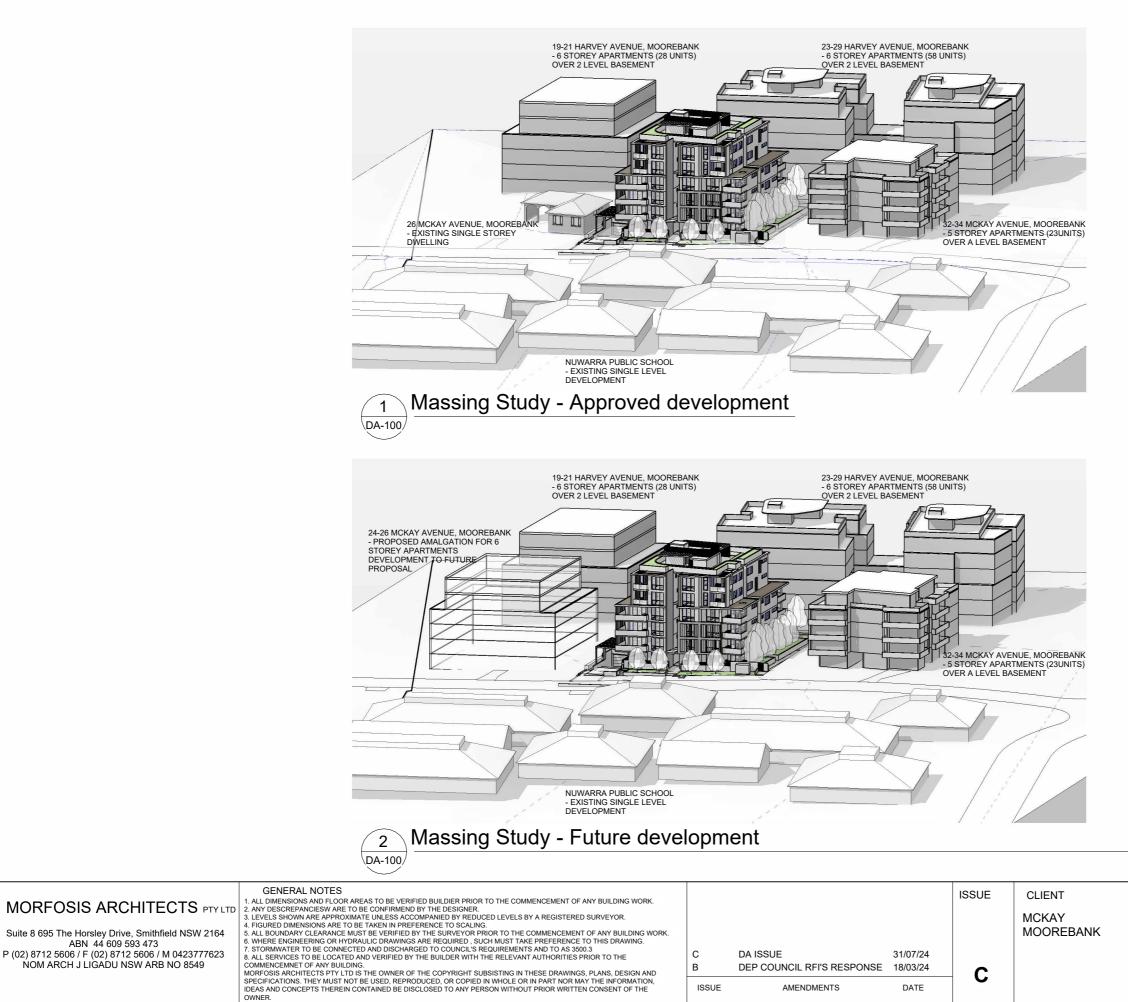

ISSUE

AMENDMENTS

DATE

OWNER.


SCAL	.E
@	A3

DA-100 DRAWING TITLE: MASSING STUDY


DRAWING NUMBER:

RESIDENTIAL FLAT BUILDING DEVELOPMENT AT 28 & 30 MCKAY AVENUE MOOREBANK

PROJECT

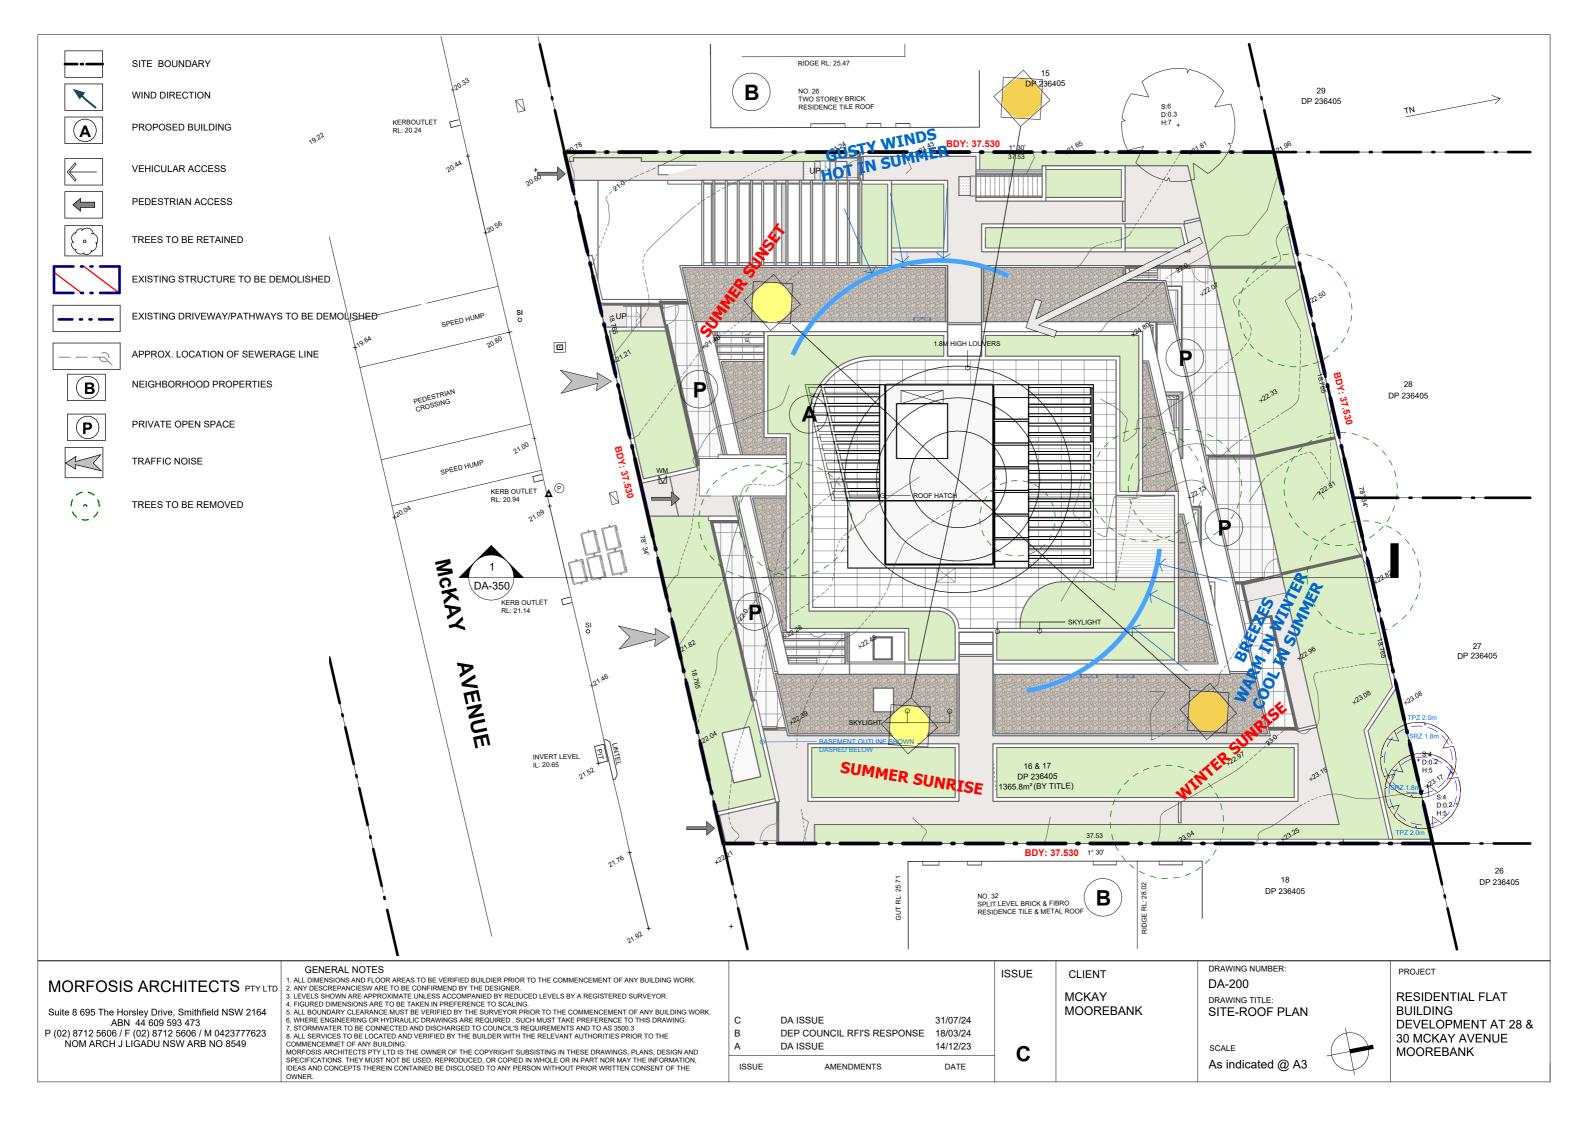

NTR	NON-TRAFFICABLE ROOF
P.O.S	PRIVATE OPEN SPACE
AC	A/C CONDENSER UNIT WITH SLAT SCREEN ENSLOSURE 1.1M H. REFER DETAIL
	STRUCTURAL ROOT ZONE
	TREE PROTECTION ZONE
	TREE TO BE REMOVED
	1 BEDROOM UNIT
	1 BEDROOM ADAPTABLE UNIT
	2 BEDROOM UNIT
	2 BEDROOM ADAPTABLE UNIT
	3 BEDROOM UNIT
	SHAFT
BC/ B	BIN CHUTE/ BINS ROOM
	LANDSCAPE

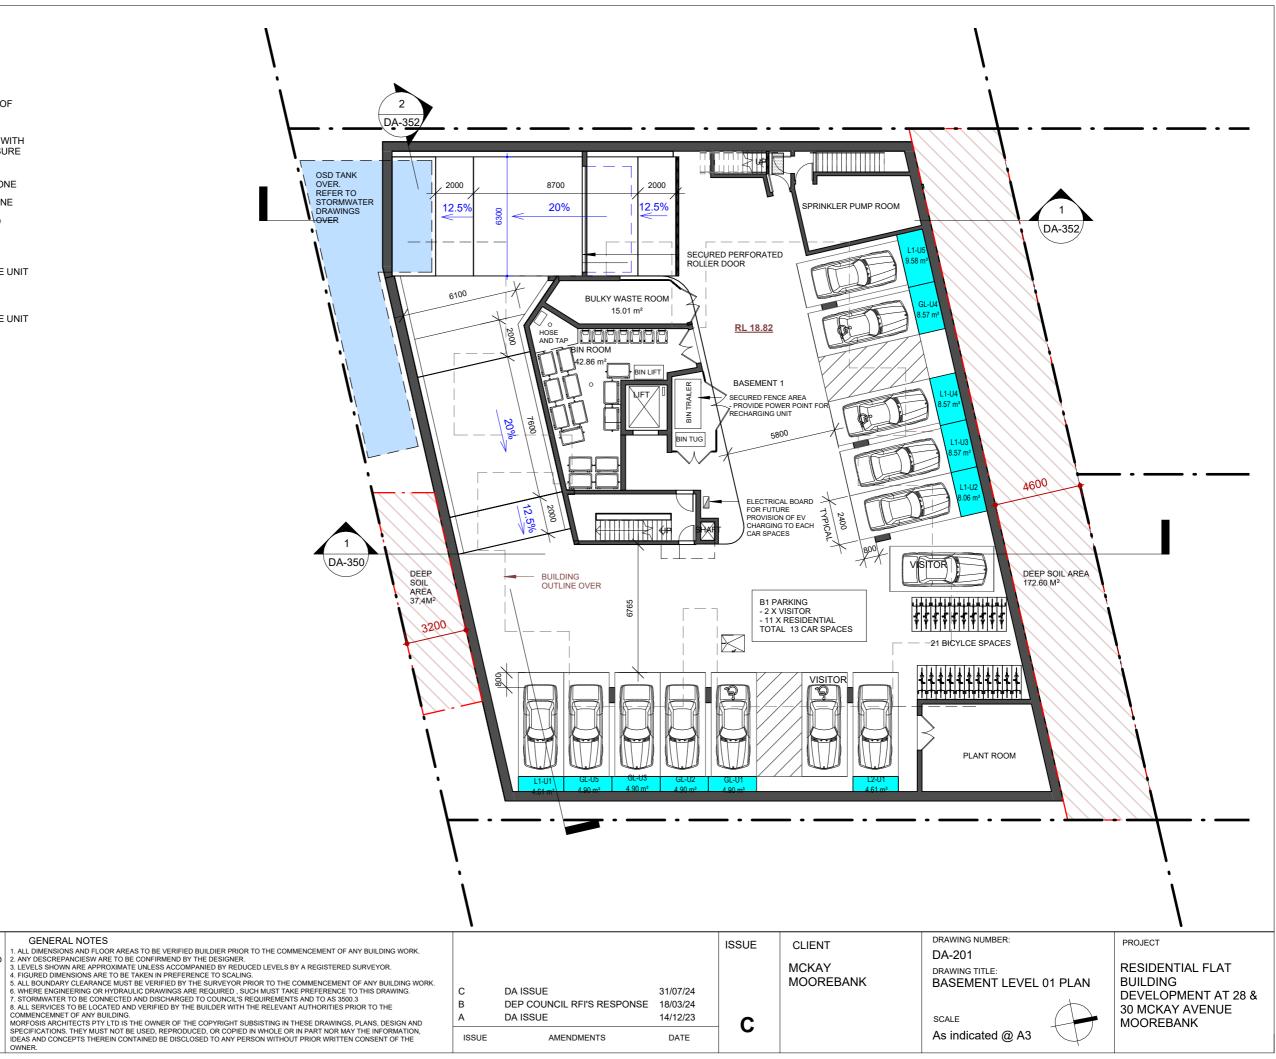


MORFOSIS ARCHITECTS PTY LTD

Suite 8 695 The Horsley Drive, Smithfield NSW 2164 ABN 44 609 593 473 P (02) 8712 5606 / F (02) 8712 5606 / M 0423777623 NOM ARCH J LIGADU NSW ARB NO 8549 GENERAL NOTES

			ISSUE	CLIENT	
-				MCKAY MOOREBANK	
С	DA ISSUE	31/07/24			
В	DEP COUNCIL RFI'S RESPONSE	18/03/24			
А	DA ISSUE	14/12/23	С		
ISSUE	AMENDMENTS	DATE	C		


OWNER.

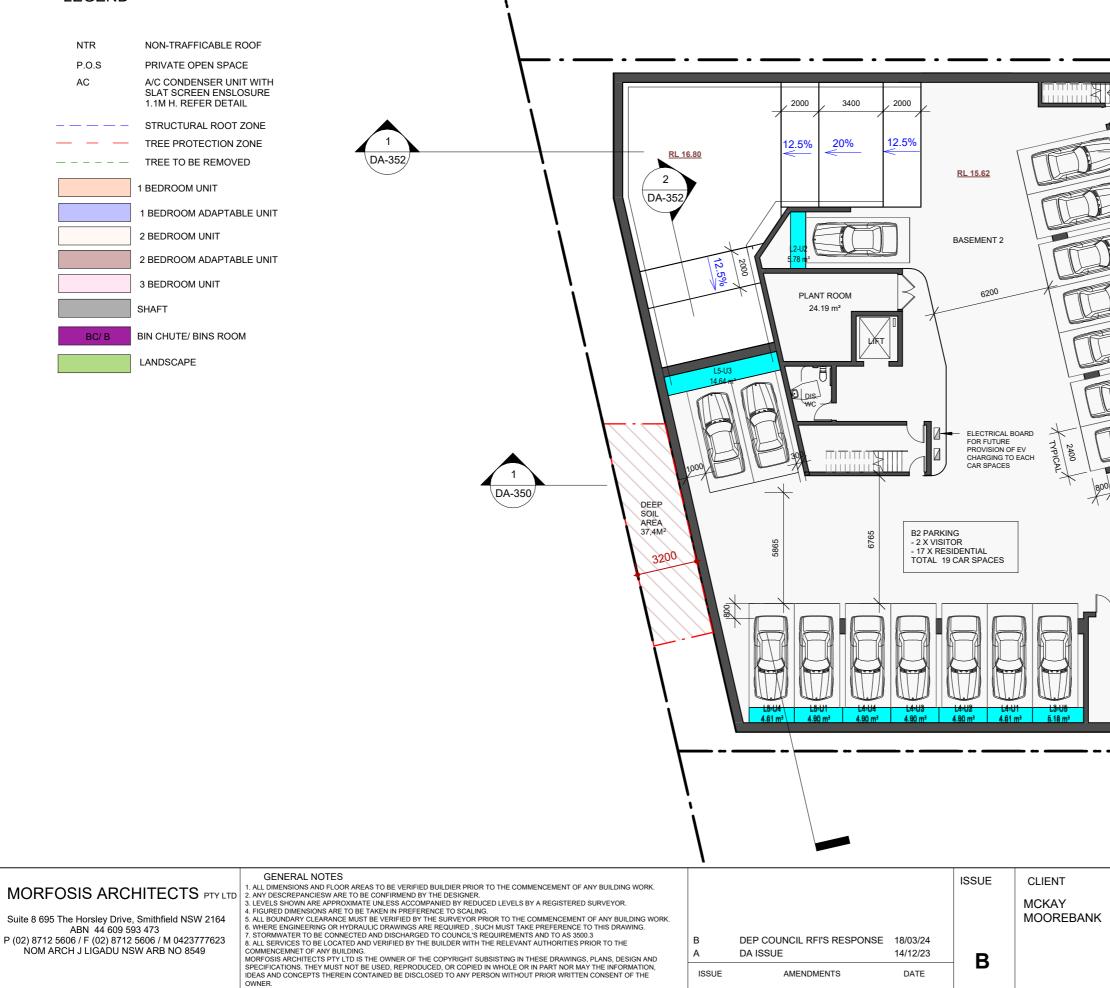


ISSUE

AMENDMENTS

DATE

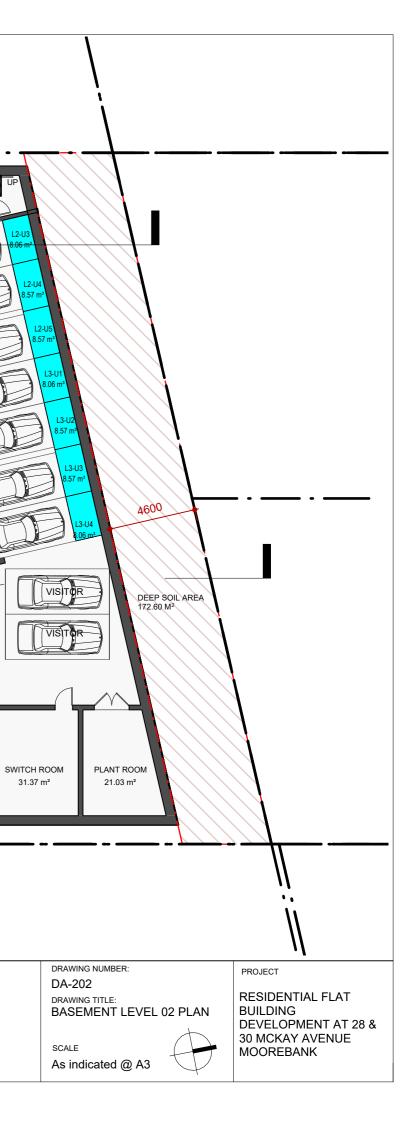

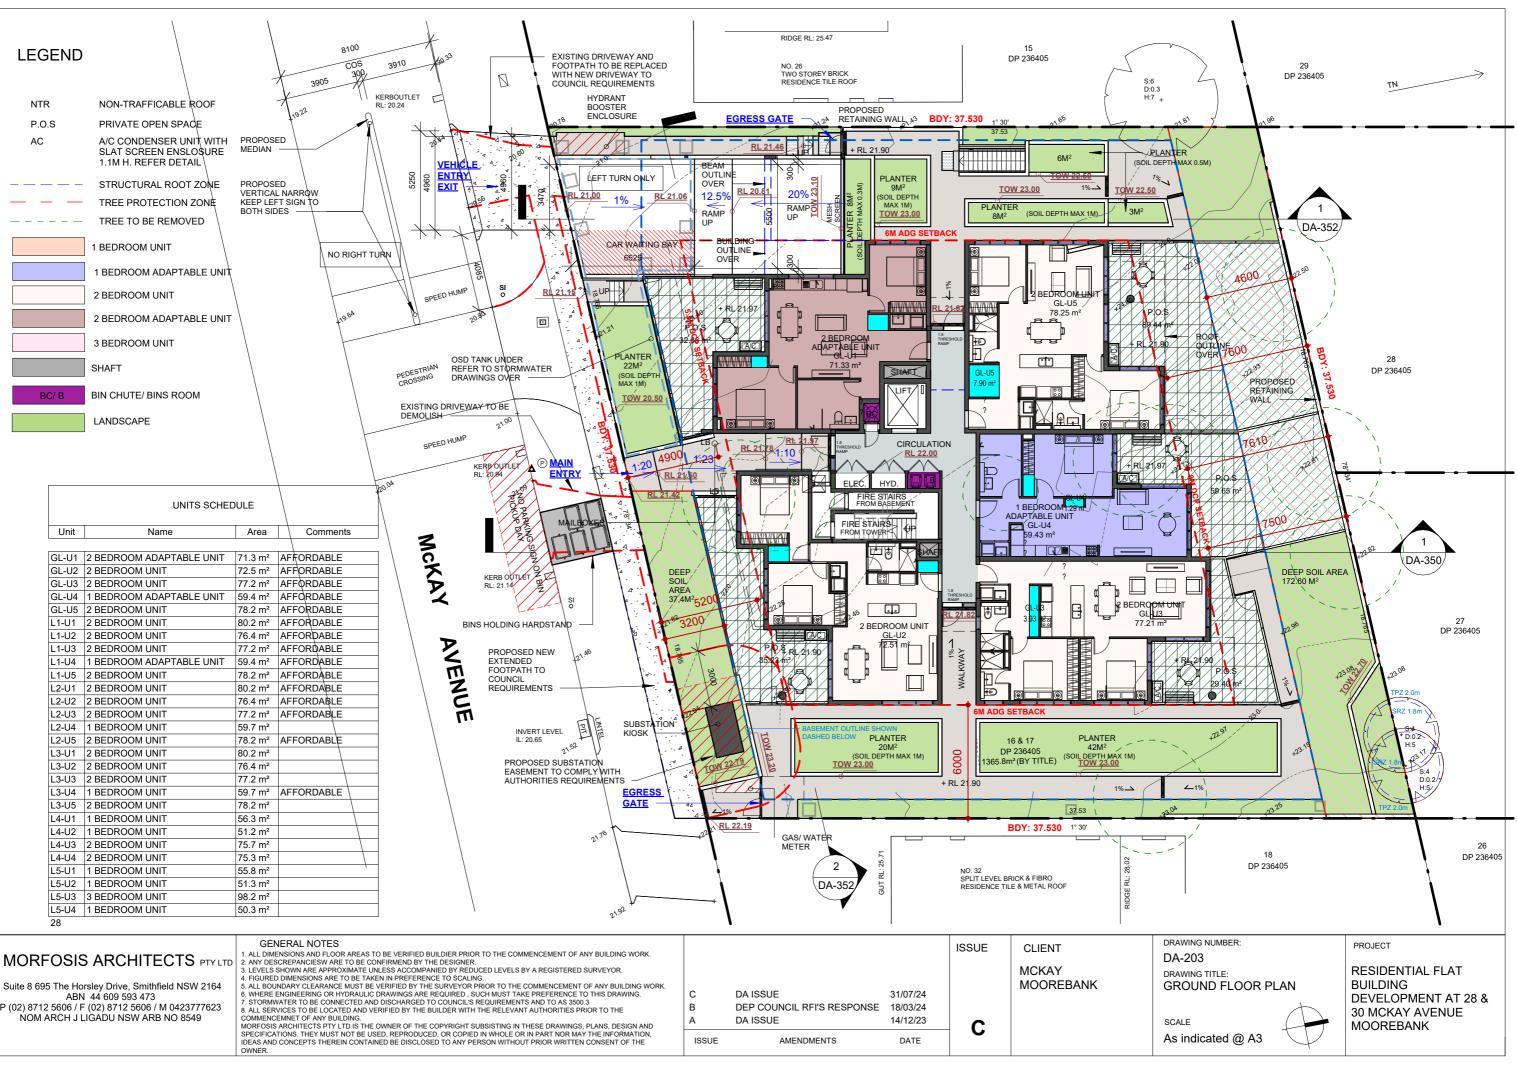


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				MCKAY	
C B	DA ISSUE DEP COUNCIL RFI'S RESPONSE	31/07/24 18/03/24		MOOREBANK	
A	DA ISSUE	14/12/23	С		
ISSUE	AMENDMENTS	DATE			
					_

NTR	NON-TRAFFICABLE ROOF
P.O.S	PRIVATE OPEN SPACE
AC	A/C CONDENSER UNIT WITH SLAT SCREEN ENSLOSURE 1.1M H. REFER DETAIL
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	TREE PROTECTION ZONE
	TREE TO BE REMOVED
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	2 BEDROOM UNIT
	2 BEDROOM ADAPTABLE UNIT
	3 BEDROOM UNIT
	SHAFT
BC/ B	BIN CHUTE/ BINS ROOM
	LANDSCAPE

	UNITS SCHEDULE				
Unit	Name	Area	Comments		
			1		
GL-U1	2 BEDROOM ADAPTABLE UNIT	71.3 m ²	AFFORDABLE		
GL-U2	2 BEDROOM UNIT	72.5 m ²	-		
GL-U3	2 BEDROOM UNIT	77.2 m ²	AFFORDABLE		
GL-U4	1 BEDROOM ADAPTABLE UNIT	59.4 m ²	AFFORDABLE		
GL-U5	2 BEDROOM UNIT	78.2 m ²	AFFORDABLE		
L1-U1	2 BEDROOM UNIT	80.2 m ²	AFFORDABLE		
L1-U2	2 BEDROOM UNIT	76.4 m ²	AFFORDABLE		
L1-U3	2 BEDROOM UNIT	77.2 m ²	AFFORDABLE		
L1-U4	1 BEDROOM ADAPTABLE UNIT	59.4 m ²	AFFORDABLE		
L1-U5	2 BEDROOM UNIT	78.2 m ²	AFFORDABLE		
L2-U1	2 BEDROOM UNIT	80.2 m ²	AFFORDABLE		
L2-U2	2 BEDROOM UNIT	76.4 m ²	AFFORDABLE		
L2-U3	2 BEDROOM UNIT	77.2 m ²	AFFORDABLE		
L2-U4	1 BEDROOM UNIT	59.7 m ²			
L2-U5	2 BEDROOM UNIT	78.2 m ²	AFFORDABLE		
L3-U1	2 BEDROOM UNIT	80.2 m ²			
L3-U2	2 BEDROOM UNIT	76.4 m ²			
L3-U3	2 BEDROOM UNIT	77.2 m ²			
L3-U4	1 BEDROOM UNIT	59.7 m ²	AFFORDABLE		
L3-U5	2 BEDROOM UNIT	78.2 m ²			
L4-U1	1 BEDROOM UNIT	56.3 m ²			
L4-U2	1 BEDROOM UNIT	51.2 m ²			
L4-U3	2 BEDROOM UNIT	75.7 m ²			
L4-U4	2 BEDROOM UNIT	75.3 m ²			
L5-U1	1 BEDROOM UNIT	55.8 m ²			
L5-U2	1 BEDROOM UNIT	51.3 m ²			
L5-U3	3 BEDROOM UNIT	98.2 m ²			
L5-U4	1 BEDROOM UNIT	50.3 m ²			

28

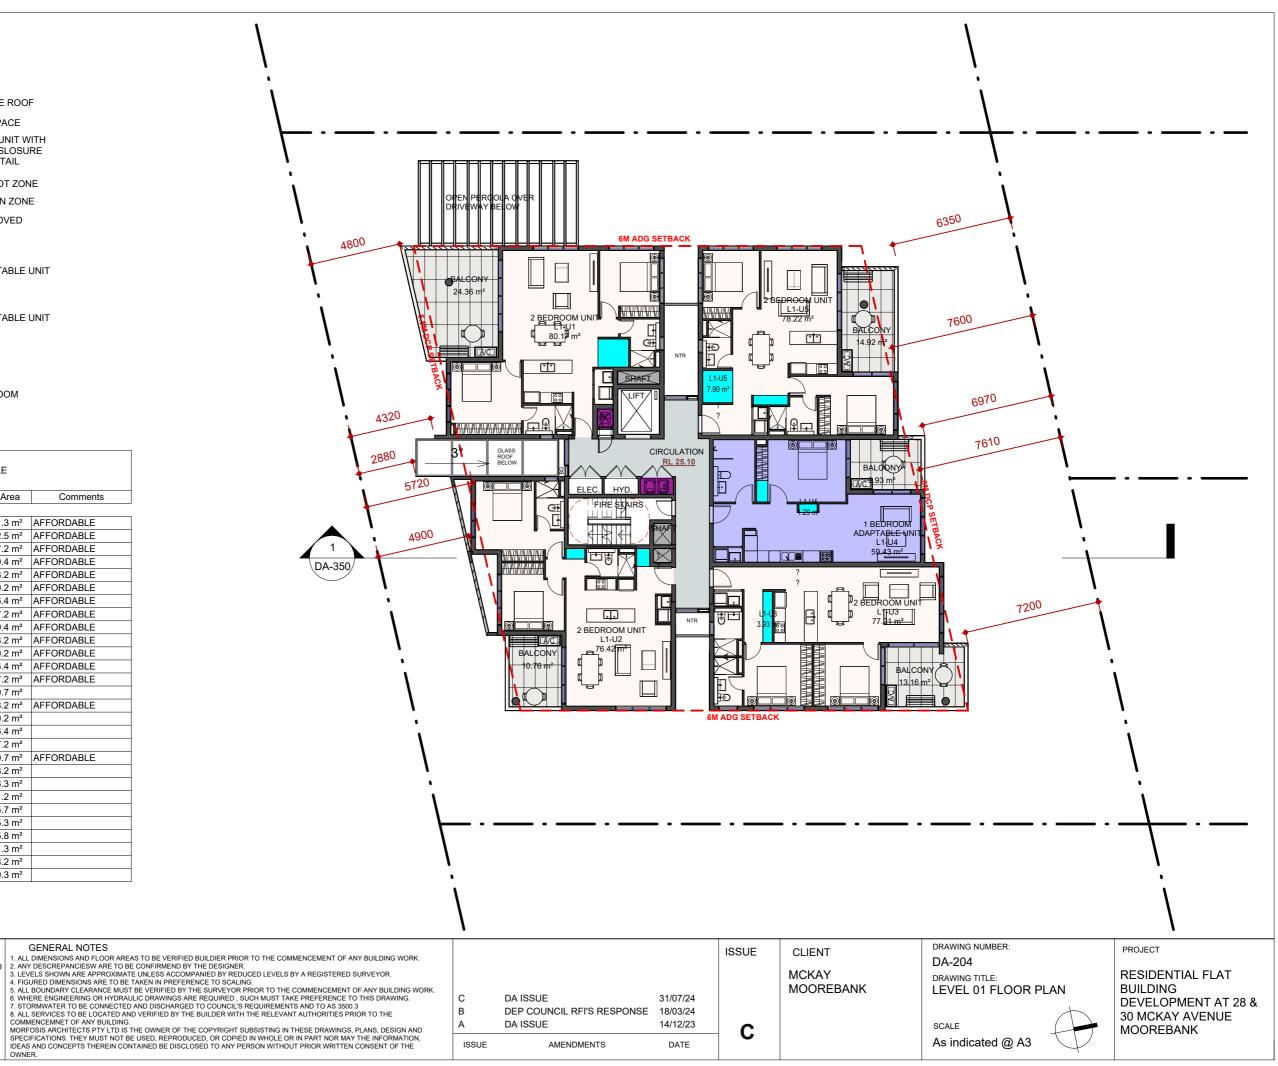

MORFOSIS ARCHITECTS PTY LTD

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GENERAL NOTES

			ISSUE	CLIENT	
		0.4 107 10.4		MCKAY MOOREBANK	
С	DA ISSUE	31/07/24			
В	DEP COUNCIL RFI'S RESPONSE	18/03/24			
А	DA ISSUE	14/12/23	С		
ISSUE	AMENDMENTS	DATE			

NTR	NON-TRAFFICABLE ROOF
P.O.S	PRIVATE OPEN SPACE
AC	A/C CONDENSER UNIT WITH SLAT SCREEN ENSLOSURE 1.1M H. REFER DETAIL
	STRUCTURAL ROOT ZONE
	TREE PROTECTION ZONE
	TREE TO BE REMOVED
	1 BEDROOM UNIT
	1 BEDROOM ADAPTABLE UNIT
	2 BEDROOM UNIT
	2 BEDROOM ADAPTABLE UNIT
	3 BEDROOM UNIT
	SHAFT
BC/ B	BIN CHUTE/ BINS ROOM
	LANDSCAPE

UNITS SCHEDULE				
	Unit	Name	Area	Comments

GL-U1	2 BEDROOM ADAPTABLE UNIT	71.3 m ²	AFFORDABLE
GL-U2	2 BEDROOM UNIT	72.5 m ²	AFFORDABLE
GL-U3	2 BEDROOM UNIT	77.2 m ²	AFFORDABLE
GL-U4	1 BEDROOM ADAPTABLE UNIT	59.4 m ²	AFFORDABLE
GL-U5	2 BEDROOM UNIT	78.2 m ²	AFFORDABLE
L1-U1	2 BEDROOM UNIT	80.2 m ²	AFFORDABLE
L1-U2	2 BEDROOM UNIT	76.4 m ²	AFFORDABLE
L1-U3	2 BEDROOM UNIT	77.2 m ²	AFFORDABLE
L1-U4	1 BEDROOM ADAPTABLE UNIT	59.4 m ²	AFFORDABLE
L1-U5	2 BEDROOM UNIT	78.2 m ²	AFFORDABLE
L2-U1	2 BEDROOM UNIT	80.2 m ²	AFFORDABLE
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L4-U3	2 BEDROOM UNIT	75.7 m ²	
L4-U4	2 BEDROOM UNIT	75.3 m ²	
L5-U1	1 BEDROOM UNIT	55.8 m ²	
L5-U2	1 BEDROOM UNIT	51.3 m ²	
L5-U3	3 BEDROOM UNIT	98.2 m ²	
L5-U4	1 BEDROOM UNIT	50.3 m ²	
20			

GENERAL NOTES

28




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GENERAL NOTES 1. ALL DIMENSIONS AND FLOOR AREAS TO BE VERIFIED BUILDIER PRIOR TO THE COMMENCEMENT OF ANY BUILDING WORK. 2. ANY DESCREPANCIESW ARE TO BE CONFIRMEND BY THE DESIGNER. 3. LEVELS SHOWN ARE APPROXIMMATE UNLESS ACCOMPANIED BY REDUCED LEVELS BY A REGISTERED SURVEYOR. 4. FIGURED DIMENSIONS ARE TO BE TAKEN IN PREFERENCE TO SCALING. 5. ALL BOUNDARY CLEARANCE MUST BE VERIFIED BY THE SURVEYOR PRIOR TO THE COMMENCEMENT OF ANY BUILDING WORK. 6. WHERE ENGINEERING OR HYDRAULIC DRAWINGS ARE REQUIRED, SUCH MUST TAKE PREFERENCE TO THIS DRAWING. 7. STORMWATER TO BE CONNECTED AND DISCHARGED TO COUNCL'S REQUIREMENTS AND TO AS 3500.3 8. ALL SERVICES TO BE LOCATED AND DISCHARGED TO COUNCL'S REQUIREMENTS AND TO AS 3500.3 8. ALL SERVICES TO BE LOCATED AND VERIFIED BY THE BUILDER WITH THE RELEVANT AUTHORITIES PRIOR TO THE COMMENCEMNET OF ANY BUILDING. MORFOSIS ARCHITECTS PTV LTD IS THE OWNER OF THE COPYRIGHT SUBSISTING IN THESE DRAWINGS, PLANS, DESIGN AND SPECIFICATIONS. THEY MUST NOT BE USED, REPRODUCED, OC COPIED IN WHOLE OR IN PART NOR MAY THE INFORMATION, IDEAS AND CONCEPTS THEREIN CONTAINED BE DISCLOSED TO ANY PERSON WITHOUT PRIOR WRITTEN CONSENT OF THE OWNER.

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A DA ISSUE 14/12/23	
B DEP COUNCIL RFI'S RESPONSE 18/03/24	
C DA ISSUE 31/07/24	MOOREBANK
ISSUE	CLIENT



NTR	NON-TRAFFICABLE ROOF
P.O.S	PRIVATE OPEN SPACE
AC	A/C CONDENSER UNIT WITH SLAT SCREEN ENSLOSURE 1.1M H. REFER DETAIL
	STRUCTURAL ROOT ZONE
	TREE PROTECTION ZONE
	TREE TO BE REMOVED
	1 BEDROOM UNIT
	1 BEDROOM ADAPTABLE UNIT
	2 BEDROOM UNIT
	2 BEDROOM ADAPTABLE UNIT
	3 BEDROOM UNIT
	SHAFT
BC/ B	BIN CHUTE/ BINS ROOM
	LANDSCAPE

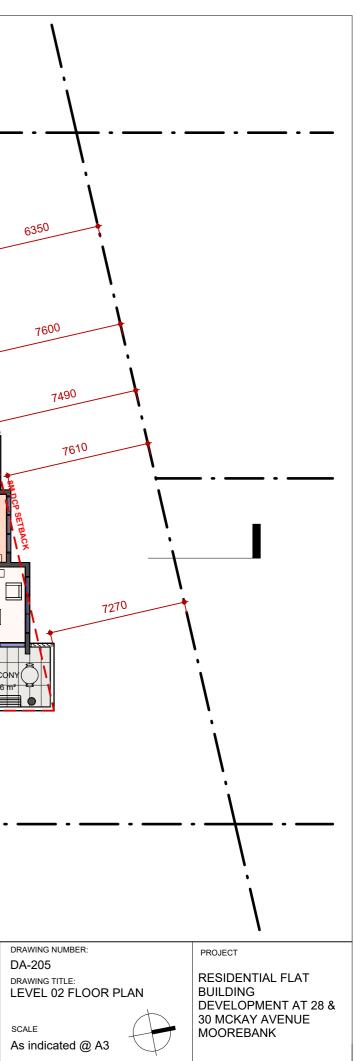	UNITS SCHEDULE						
Unit	Name	Area	Comments				
	1						
GL-U1	2 BEDROOM ADAPTABLE UNIT	71.3 m ²	AFFORDABLE				
GL-U2	2 BEDROOM UNIT	72.5 m ²	AFFORDABLE				
GL-U3	2 BEDROOM UNIT	77.2 m ²	AFFORDABLE				
GL-U4	1 BEDROOM ADAPTABLE UNIT	59.4 m ²	AFFORDABLE				
GL-U5	2 BEDROOM UNIT	78.2 m ²	AFFORDABLE				
L1-U1	2 BEDROOM UNIT	80.2 m ²	AFFORDABLE				
L1-U2	2 BEDROOM UNIT	76.4 m ²	AFFORDABLE				
L1-U3	2 BEDROOM UNIT	77.2 m ²	AFFORDABLE				
L1-U4	1 BEDROOM ADAPTABLE UNIT	59.4 m ²	AFFORDABLE				
L1-U5	2 BEDROOM UNIT	78.2 m ²	AFFORDABLE				
L2-U1	2 BEDROOM UNIT	80.2 m ²	AFFORDABLE				
L2-U2	2 BEDROOM UNIT	76.4 m ²	AFFORDABLE				
L2-U3	2 BEDROOM UNIT	77.2 m ²	AFFORDABLE				
L2-U4	1 BEDROOM UNIT	59.7 m ²					
L2-U5	2 BEDROOM UNIT	78.2 m ²	AFFORDABLE				
L3-U1	2 BEDROOM UNIT	80.2 m ²					
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L4-U2	1 BEDROOM UNIT	51.2 m ²					
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L5-U1	1 BEDROOM UNIT	55.8 m ²					
L5-U2	1 BEDROOM UNIT	51.3 m ²					
L5-U3	3 BEDROOM UNIT	98.2 m ²					
L5-U4	1 BEDROOM UNIT	50.3 m ²					

28



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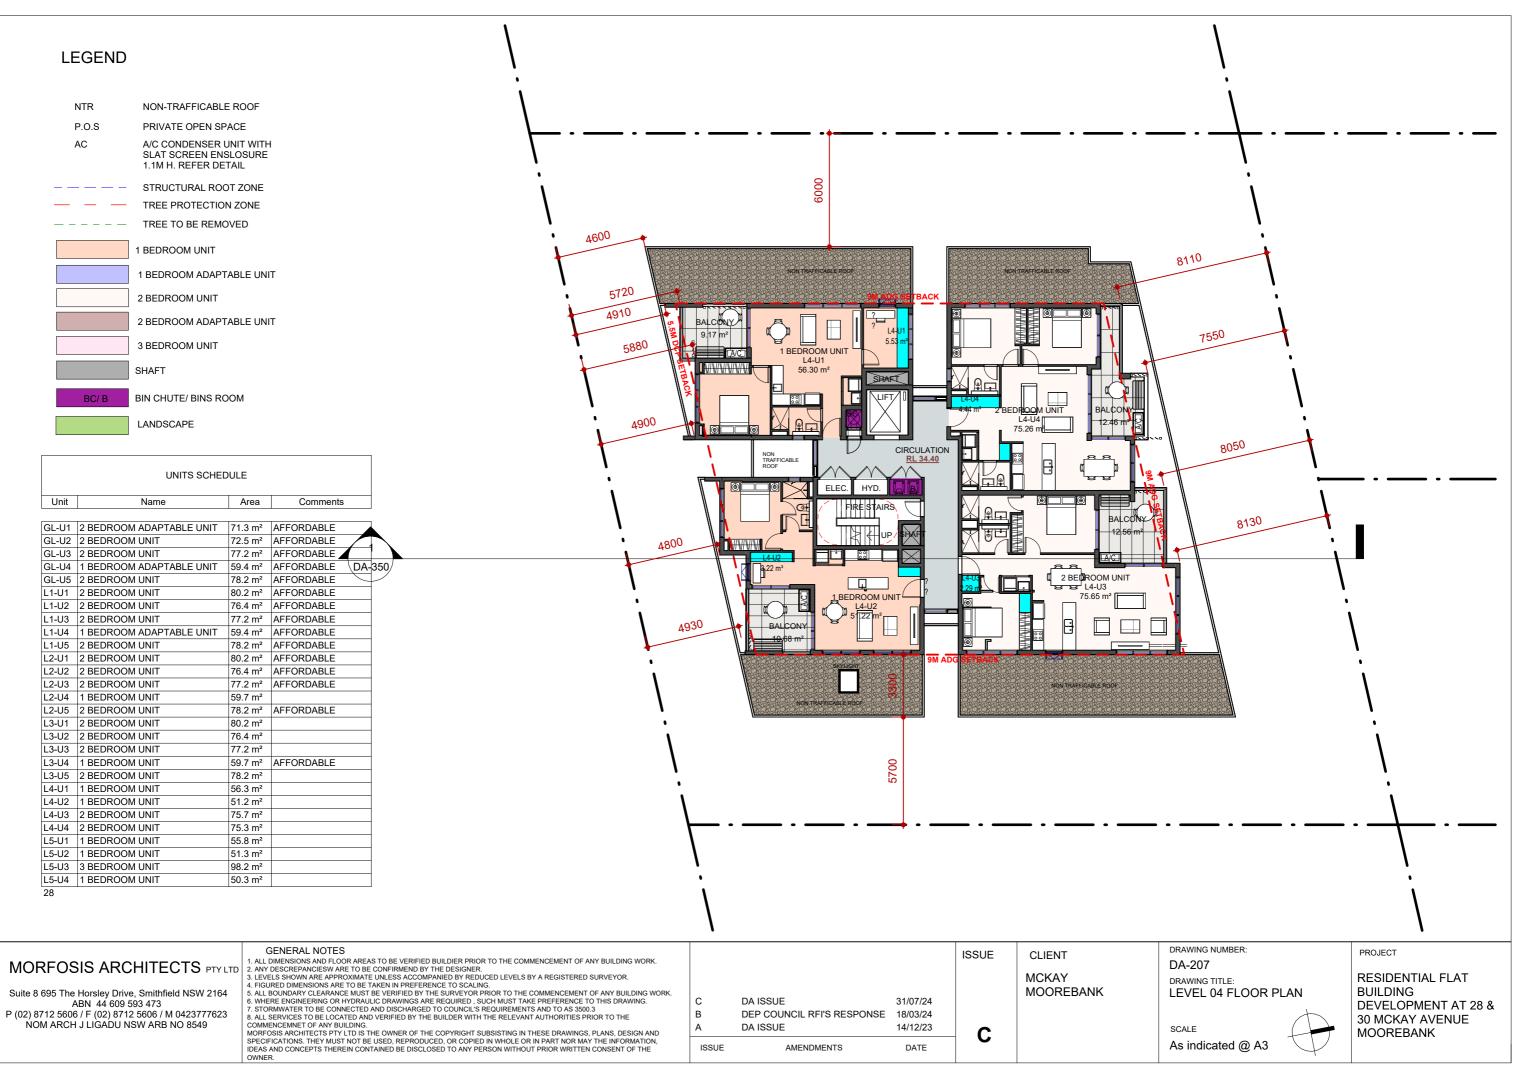
GENERAL NOTES

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6. WHERE ENGINEERING OR HYDRAULIC DRAWINGS ARE REQUIRED, SUCH MUST TAKE PREFRENCE TO THIS DRAWING.
7. STORMWATER TO BE CONNECTED AND DYNAMIC OCUNCIL'S REQUIREMENTS AND TO AS \$300.3
8. ALL SERVICES TO BE LOCATED AND VERIFIED BY THE BUILDER WITH THE RELEVANT AUTHORITIES PRIOR TO THE COMMENCEMENT OF ANY BUILDING.
MORFOSIS ARCHITECTS PTV LTD IS THE OWNER OF THE COPYRICHT SUBSISTING IN THESE DRAWINGS, PLANS, DESIGN AND SPECIFICATIONS. THEY MUST NOT BE USED, REPRODUCED, OR COPIED IN WHOLE OR IN PART NOR MAY THE INFORMATION, IDEAS AND CONCEPTS THEREIN CONTAINED BE DISCLOSED TO ANY PERSON WITHOUT PRIOR WRITTEN CONSENT OF THE OWNER.

			ISSUE	CLIENT	
С	DA ISSUE	31/07/24		MCKAY MOOREBANK	
В	DEP COUNCIL RFI'S RESPONSE	18/03/24			
А	DA ISSUE	14/12/23	С		
ISSUE	AMENDMENTS	DATE			

	NTR	NON-TRAFFICABL	E ROOF	
	P.O.S	PRIVATE OPEN SF	PACE	
	AC	A/C CONDENSER SLAT SCREEN EN 1.1M H. REFER DE	SLOSURE	I
		STRUCTURAL ROO	OT ZONE	
		TREE PROTECTIO	N ZONE	
		TREE TO BE REMO	OVED	
		1 BEDROOM UNIT		
		1 BEDROOM ADAPT	TABLE UNI	т
		2 BEDROOM UNIT		
		2 BEDROOM ADAP	TARI E UNI	т
		3 BEDROOM UNIT		
		SHAFT		
		SHAFT		
	BC/ B	BIN CHUTE/ BINS RO	MOC	
		LANDSCAPE		
		UNITS SCHEI	DULE	
Unit		Name	Area	Comments
Unit		Indille	Alea	Comments
GL-U1	2 BEDROOM	ADAPTABLE UNIT	71.3 m ²	AFFORDABLE
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GL-U5	2 BEDROOM	/ UNIT	78.2 m ²	AFFORDABLE
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L4-U1	1 BEDROOM		56.3 m ²	
L4-U2	1 BEDROOM	-	51.2 m ²	
L4-U3	2 BEDROOM		75.7 m ²	
L4-03	2 BEDROOM		75.3 m ²	
L5-U1	1 BEDROOM		55.8 m ²	
L5-U2	1 BEDROOM		51.3 m ²	
L5-U2	3 BEDROOM		98.2 m ²	
L5-U3	1 BEDROOM		50.3 m ²	
L5-U4	I DEDRUUN		50.5 m	

28



NON-TRAFFICABLE ROOF
PRIVATE OPEN SPACE
A/C CONDENSER UNIT WITH SLAT SCREEN ENSLOSURE 1.1M H. REFER DETAIL
STRUCTURAL ROOT ZONE
TREE PROTECTION ZONE
TREE TO BE REMOVED
1 BEDROOM UNIT
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2 BEDROOM UNIT
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L5-U2	1 BEDROOM UNIT	51.3 m ²				
L5-U3	3 BEDROOM UNIT	98.2 m ²				
L5-U4	1 BEDROOM UNIT	50.3 m ²				

GENERAL NOTES



28

MORFOSIS ARCHITECTS PTY LTD	2.


Suite 8 695 The Horsley Drive, Smithfield NSW 2164 ABN 44 609 593 473 P (02) 8712 5606 / F (02) 8712 5606 / M 0423777623 NOM ARCH J LIGADU NSW ARB NO 8549

GENERAL NOTES
1. ALL DIMENSIONS AND FLOOR AREAS TO BE VERIFIED BUILDIER PRIOR TO THE COMMENCEMENT OF ANY BUILDING WORK.
2. ANY DESCREPANCIESW ARE TO BE CONFIRMEND BY THE DESIGNER.
3. LEVELS SHOWN ARE APROXIMMET UNLESS ACCOMPANIED BY REDUCED LEVELS BY A REGISTERED SURVEYOR.
4. FIGURED DIMENSIONS ARE TO BE TAKEN IN PREFERENCE TO SCALING.
5. ALL BOUNDARY CLEARANCE MUST BE VERIFIED BY THE SURVEYOR PRIOR TO THE COMMENCEMENT OF ANY BUILDING WORK.
6. WHERE ENGINEERING OR HYDRAULIC DRAWINGS ARE REQUIRED, SUCH MUST TAKE PREFERENCE TO THIS DRAWING.
7. STORMWATER TO BE CONNECTED AND DISCHARGED TO COUNCIL'S REQUIREMENTS AND TO AS 3500.3
8. ALL SERVICES TO BE LOCATED AND VERIFIED BY THE DUILDER WITH THE RELEVANT AUTHORITIES PRIOR TO THE COMMENCEMNET OF ANY BUILDING.
MORFOSIS ARCHITECTS PTY LTD IS THE OWNER OF THE COPYRIGHT SUBSISTING IN THESE DRAWINGS, PLANS, DESIGN AND SPECIFICATIONS. THEY MUST NOT BE USED, SEPRODUCED, OR COPIED IN WHOLE OR IN PART NOR MAY THE INFORMATION, IDEAS AND CONCEPTS THEREIN CONTAINED BE DISCLOSED TO ANY PERSON WITHOUT PRIOR WRITTEN CONSENT OF THE OWNER.

1


DA-350

			ISSUE	CLIENT	
С	DA ISSUE	31/07/24		MCKAY MOOREBANK	
В	DEP COUNCIL RFI'S RESPONSE				
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A	DA ISSUE	14/12/23	С		
ISSUE	AMENDMENTS	DATE			
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OWNER.

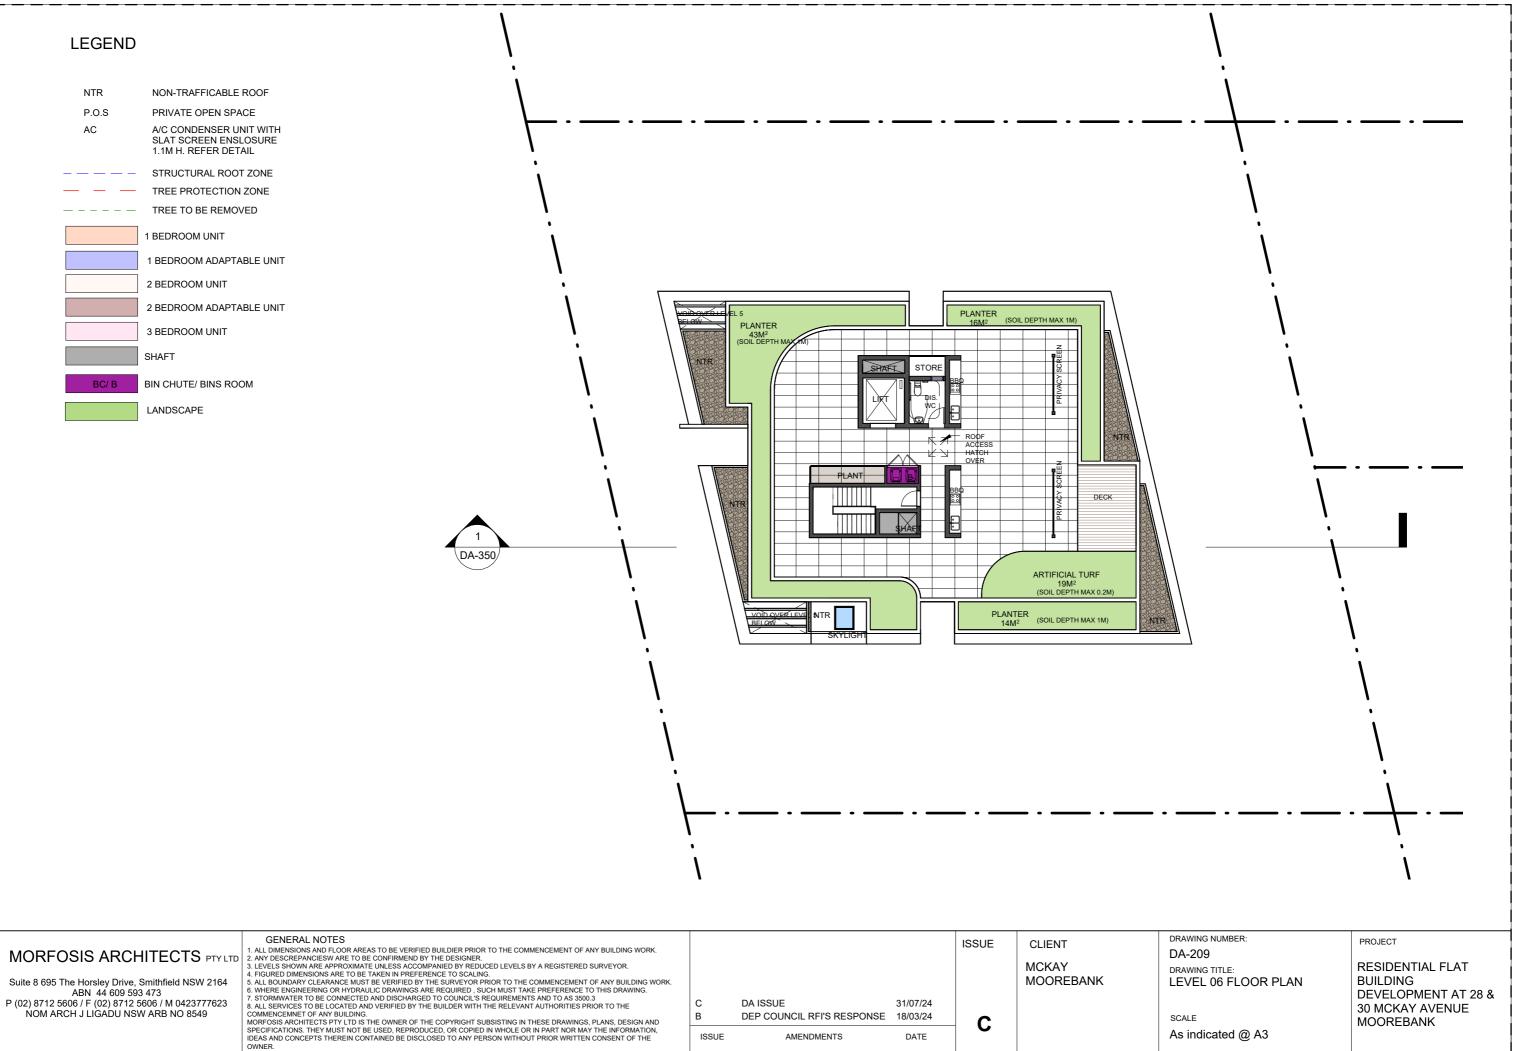
ISSUE AMENDMENTS DATE



	GENERAL NOTES			ľ	ISSUE	CLIENT	DR
	 ALL DIMENSIONS AND FLOOR AREAS TO BE VERIFIED BUILDIER PRIOR TO THE COMMENCEMENT OF ANY BUILDING WORK. ANY DESCREPANCIESW ARE TO BE CONFIRMEND BY THE DESIGNER. 			1			D/
	2. ANT DESCREPANCIES WARE TO BE CONFIRMEND BT THE DESIGNER. 3. LEVELS SHOWN ARE APPROXIMATE UNLESS ACCOMPANIED BY REDUCED LEVELS BY A REGISTERED SURVEYOR.			1		MCKAY	
	4. FIGURED DIMENSIONS ARE TO BE TAKEN IN PREFERENCE TO SCALING.			1			DR
95 The Horsley Drive, Smithfield NSW 2164	 ALL BOUNDARY CLEARANCE MUST BE VERIFIED BY THE SURVEYOR PRIOR TO THE COMMENCEMENT OF ANY BUILDING WORK. WHERE ENGINEERING OR HYDRAULIC DRAWINGS ARE REQUIRED. SUCH MUST TAKE PREFERENCE TO THIS DRAWING. 			1		MOOREBANK	R
ABN 44 609 593 473	 WHERE ENGINEERING OR IT DRAULE DRAWINGS ARE REQUIRED, SUCH WIGHTARE PREPERTIES IN STRAWING. T. STORWATER TO BE CONNECTED AND DISCHARGED TO COUNCIL'S REQUIREMENTS AND TO AS 3500.3 						
2 5606 / F (02) 8712 5606 / M 0423777623	8. ALL SERVICES TO BE LOCATED AND VERIFIED BY THE BUILDER WITH THE RELEVANT AUTHORITIES PRIOR TO THE	C	DA ISSUE	31/07/24			
ARCH J LIGADU NSW ARB NO 8549	COMMENCEMNET OF ANY BUILDING. MORFOSIS ARCHITECTS PTY LTD IS THE OWNER OF THE COPYRIGHT SUBSISTING IN THESE DRAWINGS. PLANS. DESIGN AND	B	DEP COUNCIL RFI'S RESPONSE	18/03/24			sc
	SPECIFICATIONS, THEY MUST NOT BE USED, REPRODUCED, OR COPIED IN WHOLE OR IN PART NOR MAY THE INFORMATION.						
	IDEAS AND CONCEPTS THEREIN CONTAINED BE DISCLOSED TO ANY PERSON WITHOUT PRIOR WRITTEN CONSENT OF THE	ISSUE	AMENDMENTS	DATE			1
	OWNER.						

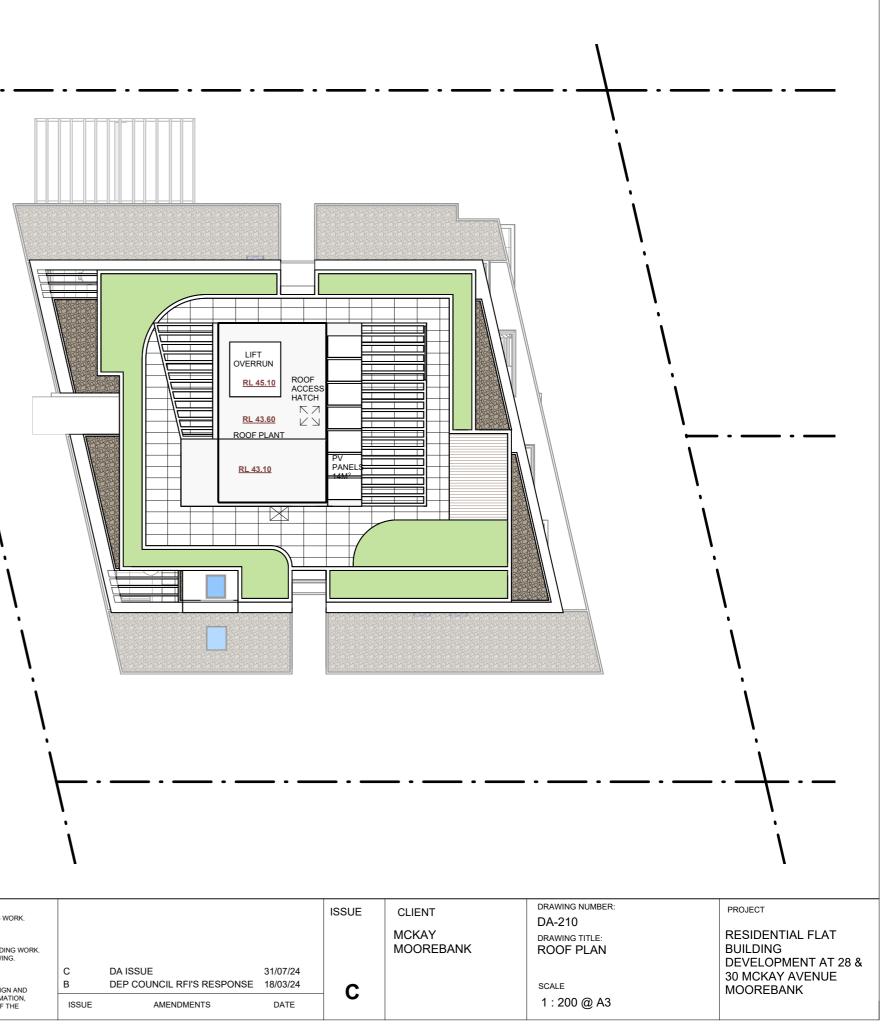MOR

Suite 8 69 P (02) 871 NOM

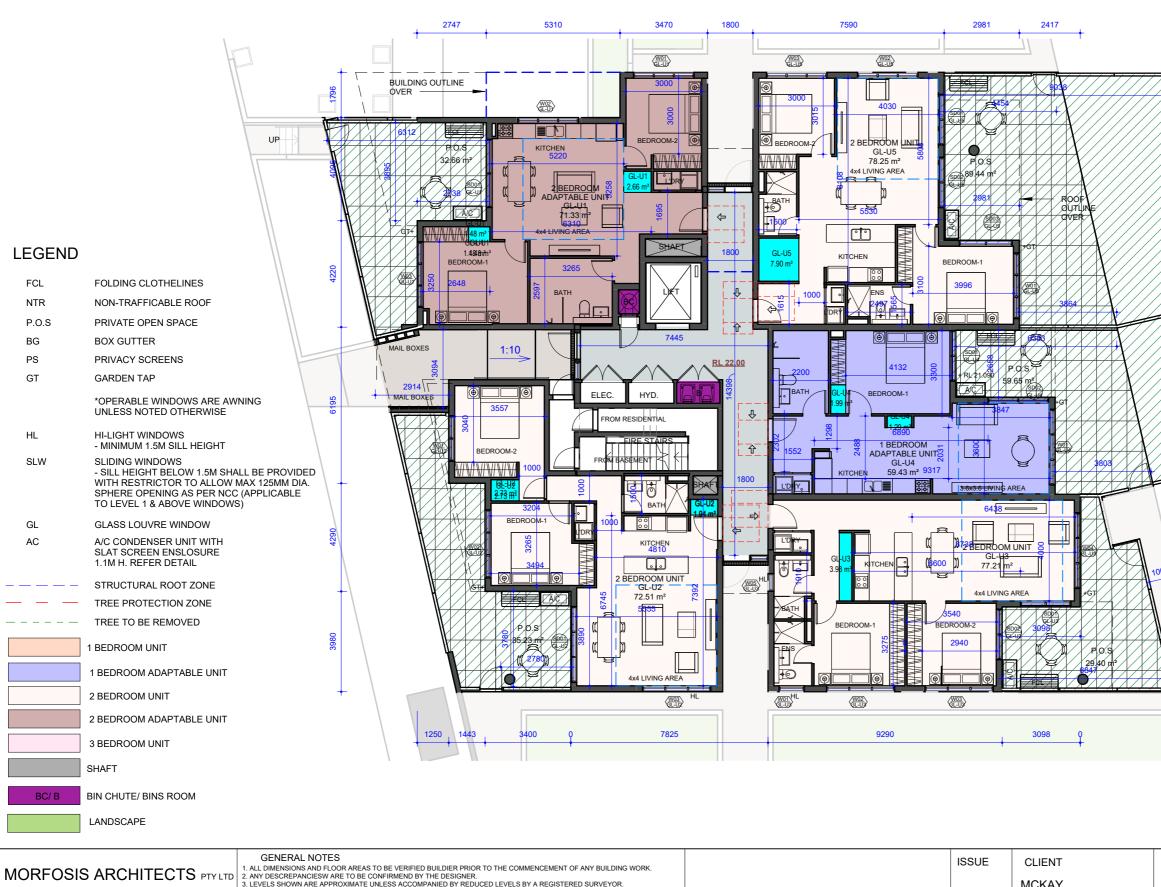

Suite 8 695 The Horsley Drive, Smithfield NSW 2164 ABN 44 609 593 473 P (02) 8712 5606 / F (02) 8712 5606 / M 0423777623 NOM ARCH J LÌGADU NSW ARB NO 8549

OWNER.

GENERAL NOTES
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SPECIFICATIONS. THEY MUST NOT BE USED, REPRODUCED, OR COPIED IN WHOLE OR IN PART NOR MAY THE INFORMATION,
IDEAS AND CONCEPTS THEREIN CONTAINED BE DISCLOSED TO ANY PERSON WITHOUT PRIOR WRITTEN CONSENT OF THE
OWNER.

ISSUE	AMENDMENTS	DATE			
A	DA ISSUE	14/12/23	С		
В	DEP COUNCIL RFI'S RESPONSE	18/03/24			
с	DA ISSUE	31/07/24		MOOREBANK	
			ISSUE	CLIENT	


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DRAWING NUMBER: DA-211 DRAWING TITLE: DETAILED PLAN - GF LVL

SCALE As indicated @ A3



PROJECT

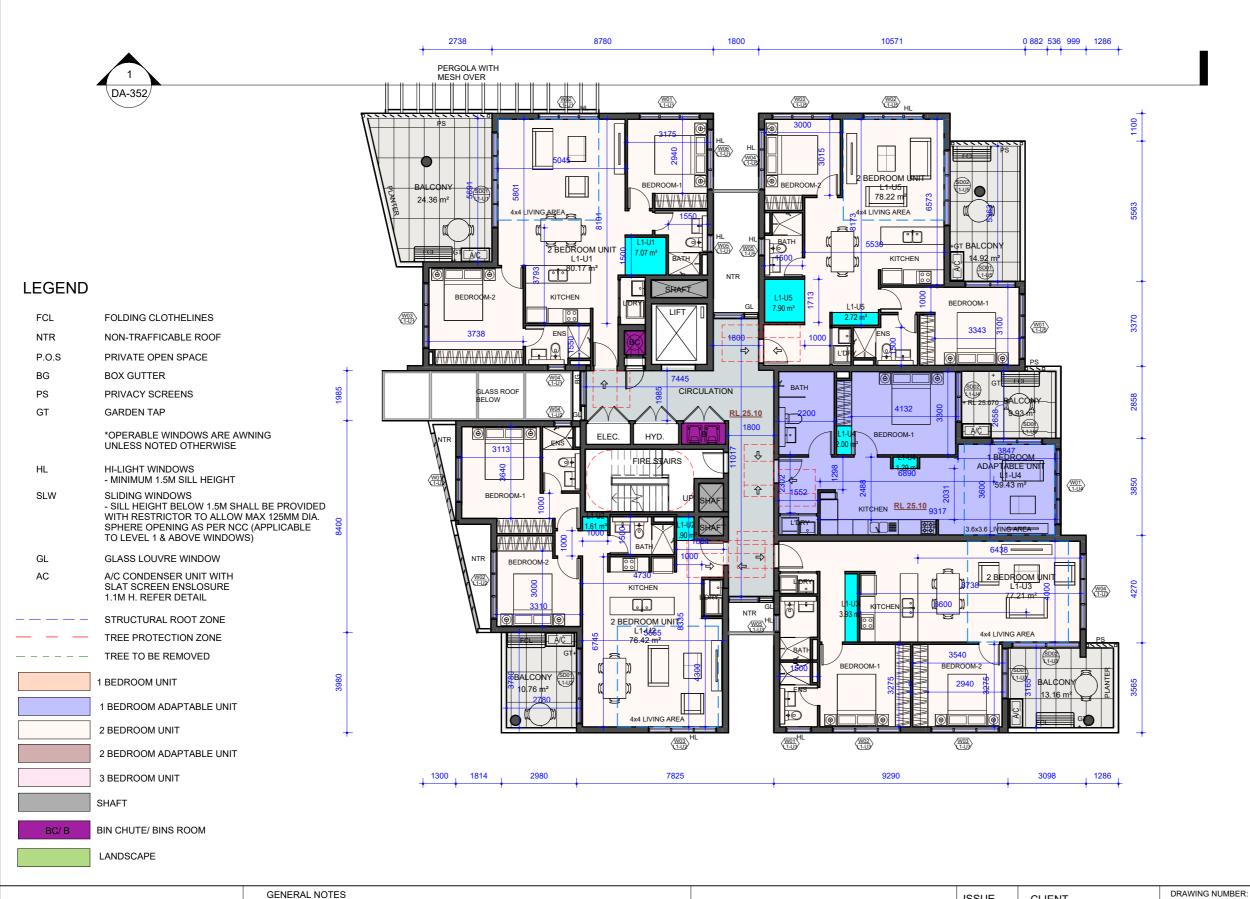

	GENERAL NOTES 1. ALL DIMENSIONS AND FLOOR AREAS TO BE VERIFIED BUILDIER PRIOR TO THE COMMENCEMENT OF ANY BUILDING WORK.				ISSUE	CLIENT	
MORFOSIS ARCHITECTS PTY LTD	ALL DIMENSIONS AND FLOOR AREAS TO BE VERIFIED BUILDIER PRIOR TO THE COMMENCEMENT OF ANY BUILDING WORK. ALL DIMENSIONS AND FLOOR AREAS TO BE CONFIRMEND BY THE DESIGNER. ALL STATUS AND ALL AND AL					MCKAY	
Suite 8 695 The Horsley Drive, Smithfield NSW 2164	 FIGURED DIMENSIONS ARE TO BE TAKEN IN PREFERENCE TO SCALING. ALL BOUNDARY CLEARANCE MUST BE VERIFIED BY THE SURVEYOR PRIOR TO THE COMMENCEMENT OF ANY BUILDING WORK. 					MOOREBANK	
ABN 44 609 593 473	 WHERE ENGINEERING OR HYDRAULIC DRAWINGS ARE REQUIRED, SUCH MUST TAKE PREFERENCE TO THIS DRAWING. STORMWATER TO BE CONNECTED AND DISCHARGED TO COUNCIL'S REQUIREMENTS AND TO AS 3500.3 	С	DA ISSUE DEP COUNCIL RFI'S RESPONSE	31/07/24			1
P (02) 8712 5606 / F (02) 8712 5606 / M 0423777623 NOM ARCH J LIGADU NSW ARB NO 8549	8. ALL SERVICES TO BE LOCATED AND VERIFIED BY THE BUILDER WITH THE RELEVANT AUTHORITIES PRIOR TO THE COMMENCEMNET OF ANY BUILDING.	B ∆	DEP COUNCIL REI'S RESPONSE DA ISSUE	18/03/24			Ι.
	MORFOSIS ARCHITECTS PTY LTD IS THE OWNER OF THE COPYRIGHT SUBSISTING IN THESE DRAWINGS, PLANS, DESIGN AND SPECIFICATIONS. THEY MUST NOT BE USED, REPRODUCED, OR COPIED IN WHOLE OR IN PART NOR MAY THE INFORMATION.	~	DA 1000E	14/12/23	C		
	IDEAS AND CONCEPTS THEREIN CONTAINED BE DISCLOSED TO ANY PERSON WITHOUT PRIOR WRITTEN CONSENT OF THE OWNER.	ISSUE	AMENDMENTS	DATE			1

SCALE	
As indicated @ A	13

DETAILED PLAN - LVL 01

DA-212


DRAWING TITLE:



RESIDENTIAL FLAT BUILDING DEVELOPMENT AT 28 & 30 MCKAY AVENUE MOOREBANK

RE

PROJECT

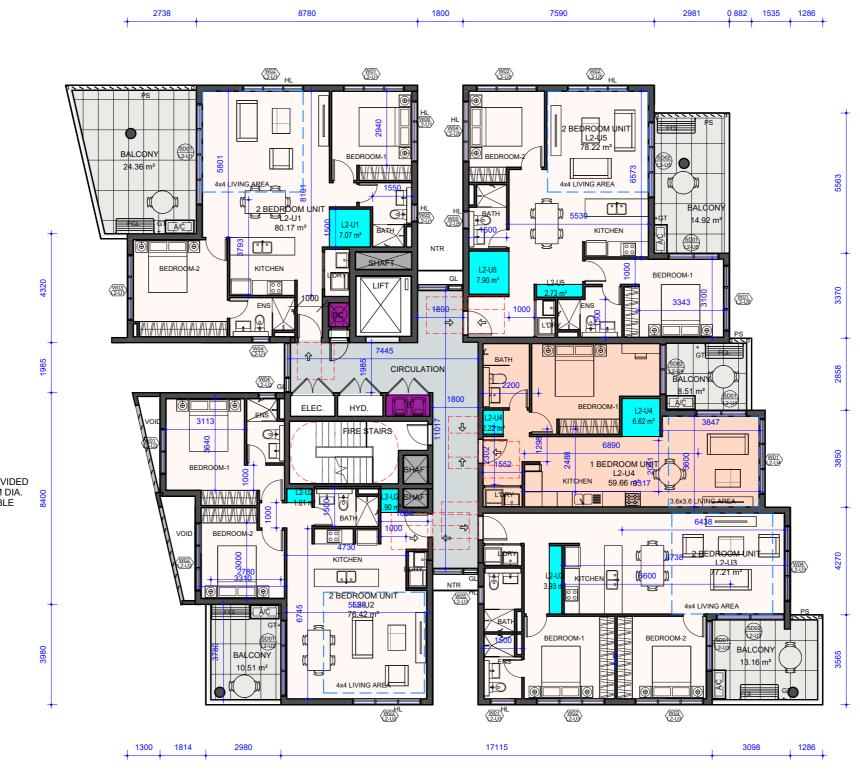


-	
FCL	FOLDING CLOTHELINES
NTR	NON-TRAFFICABLE ROOF
P.O.S	PRIVATE OPEN SPACE
BG	BOX GUTTER
PS	PRIVACY SCREENS
GT	GARDEN TAP
	*OPERABLE WINDOWS ARE AWNING UNLESS NOTED OTHERWISE
HL	HI-LIGHT WINDOWS - MINIMUM 1.5M SILL HEIGHT
SLW	SLIDING WINDOWS - SILL HEIGHT BELOW 1.5M SHALL BE PROVID WITH RESTRICTOR TO ALLOW MAX 125MM D SPHERE OPENING AS PER NCC (APPLICABLE TO LEVEL 1 & ABOVE WINDOWS)
GL	GLASS LOUVRE WINDOW
AC	A/C CONDENSER UNIT WITH SLAT SCREEN ENSLOSURE 1.1M H. REFER DETAIL
	STRUCTURAL ROOT ZONE
	TREE PROTECTION ZONE
	TREE TO BE REMOVED
	1 BEDROOM UNIT
	1 BEDROOM ADAPTABLE UNIT
	2 BEDROOM UNIT
	2 BEDROOM ADAPTABLE UNIT
	3 BEDROOM UNIT
	SHAFT
BC/ B	BIN CHUTE/ BINS ROOM
	LANDSCAPE

		GENERAL NOTES 1. ALL DIMENSIONS AND FLOOR AREAS TO BE VERIFIED BUILDIER PRIOR TO THE COMMENCEMENT OF ANY BUILDING WORK.				ISSUE	CLIENT	
	Suite 8 695 The Horsley Drive, Smithfield NSW 2164 ABN 44 609 593 473 P (02) 8712 5606 / F (02) 8712 5606 / M 0423777623	1. ALL DIMENSIONS AND FLOOR AREAS TO BE VENIFIED BUILDIER PRIOR TO THE COMMENCEMENT OF ANY BUILDING WORK. 2. ANY DESCREPANCIESW ARE TO BE CONFIRMEND BY THE DESIGNER. 3. LEVELS SHOWN ARE APPROXIMATE UNLESS ACCOMPANIED BY REDUCED LEVELS BY A REGISTERED SURVEYOR. 4. FIGURED DIMENSIONS ARE TO BE TAKEN IN PREFERENCE TO SCALING. 5. ALL BOUNDARY CLEARANCE MUST BE VERIFIED BY THE SURVEYOR PRIOR TO THE COMMENCEMENT OF ANY BUILDING WORK. 6. WHERE ENGINEERING OR HYDRAULIC DRAWINGS ARE REQUIRED, SUCH MUST TAKE PREFERENCE TO THIS DRAWING. 7. STORMWATER TO BE CONFIECTED AND DISCHARGED TO COUNCIL'S REQUIREMENTS AND TO AS 3500.3 8. ALL SERVICES TO BE LOCATED AND VERIFIED BY THE BUILDER WITH THE RELEVANT AUTHORITIES PRIOR TO THE	C B	DA ISSUE DEP COUNCIL RFI'S RESPONSE			MCKAY MOOREBANK	
	NOM ARCH J LIGADU NSW ARB NO 8549	COMMENCEMBET OF ANY BUILDING. MORFOSIS ARCHITECTS PTY LTD IS THE OWNER OF THE COPYRIGHT SUBSISTING IN THESE DRAWINGS, PLANS, DESIGN AND SPECIFICATIONS. THEY MUST NOT BE USED, REPRODUCED, OR COPIED IN WHOLE OR IN PART NOR MAY THE INFORMATION, IDEAS AND CONCEPTS THEREIN CONTAINED BE DISCLOSED TO ANY PERSON WITHOUT PRIOR WRITTEN CONSENT OF THE	A	DA ISSUE AMENDMENTS	14/12/23 DATE	C		
L		OWNER.						

SCALE	
As indicated @ A3	

DRAWING NUMBER:

DA-213 DRAWING TITLE: DETAILED PLAN - LVL 02 PROJECT

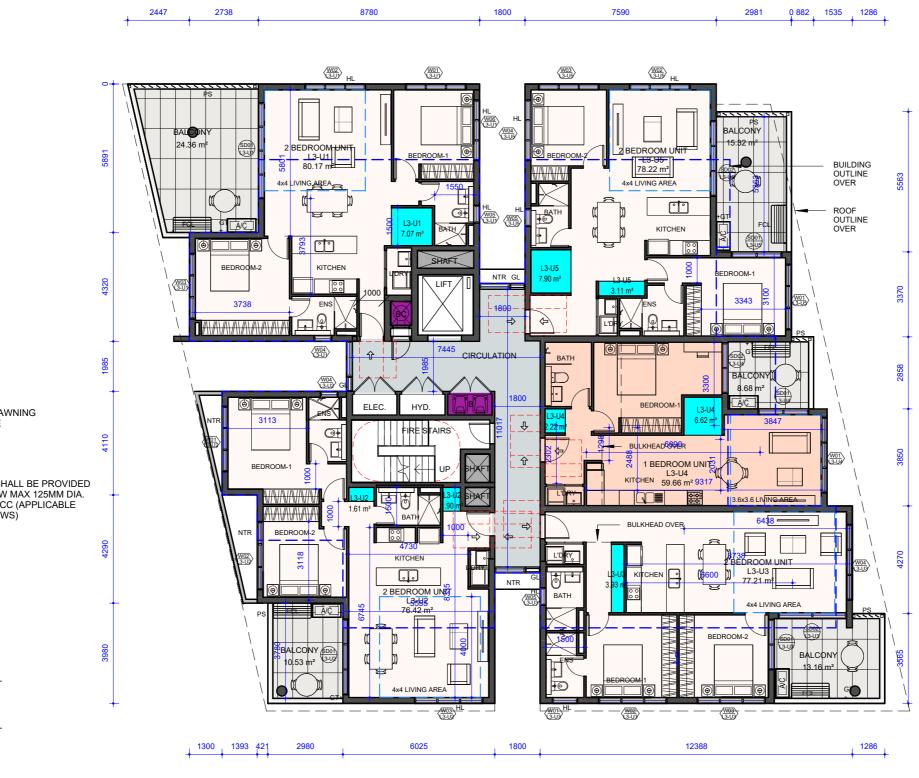

LEGEND		
FCL	FOLDING CLOTHELINES	
NTR	NON-TRAFFICABLE ROOF	
P.O.S	PRIVATE OPEN SPACE	
BG	BOX GUTTER	
PS	PRIVACY SCREENS	
GT	GARDEN TAP	
	*OPERABLE WINDOWS ARE AV UNLESS NOTED OTHERWISE	WNING
HL	HI-LIGHT WINDOWS - MINIMUM 1.5M SILL HEIGHT	
SLW	SLIDING WINDOWS - SILL HEIGHT BELOW 1.5M SH WITH RESTRICTOR TO ALLOW SPHERE OPENING AS PER NC TO LEVEL 1 & ABOVE WINDOW	MAX 125MM DI C (APPLICABLE
GL	GLASS LOUVRE WINDOW	
AC	A/C CONDENSER UNIT WITH SLAT SCREEN ENSLOSURE 1.1M H. REFER DETAIL	
	STRUCTURAL ROOT ZONE	
	TREE PROTECTION ZONE	
	TREE TO BE REMOVED	
	1 BEDROOM UNIT	
	1 BEDROOM ADAPTABLE UNIT	
	2 BEDROOM UNIT	
	2 BEDROOM ADAPTABLE UNIT	
	3 BEDROOM UNIT	
	SHAFT	
BC/ B	BIN CHUTE/ BINS ROOM	
	LANDSCAPE	
		GENERAL

	GENERAL NOTES 1. ALL DIMENSIONS AND FLOOR AREAS TO BE VERIFIED BUILDIER PRIOR TO THE COMMENCEMENT OF ANY BUILDING WORK.				ISSUE	CLIENT	
MORFOSIS ARCHITECTS PTY LTD	2. ANY DESCREPANCIESW ARE TO BE CONFIRMEND BY THE DESIGNER. 3. LEVELS SHOWN ARE APPROXIMATE UNLESS ACCOMPANIED BY REDUCED LEVELS BY A REGISTERED SURVEYOR.					MCKAY	
Suite 8 695 The Horsley Drive, Smithfield NSW 2164 ABN 44 609 593 473	 FIGURED DIMENSIONS ARE TO BE TAKEN IN PREFERENCE TO SCALING. ALL BOUNDARY CLEARANCE MUST BE VERIFIED BY THE SURVEYOR PRIOR TO THE COMMENCEMENT OF ANY BUILDING WORK. WHERE ENGINEERING OR HYDRAULIC DRAWINGS ARE REQUIRED , SUCH MUST TAKE PREFERENCE TO THIS DRAWING. 	с	DA ISSUE	31/07/24		MOOREBANK	1
P (02) 8712 5606 / F (02) 8712 5606 / M 0423777623 NOM ARCH J LIGADU NSW ARB NO 8549	STORMWATER TO BE CONNECTED AND DISCHARGED TO COUNCIL'S REQUIREMENTS AND TO AS 3500.3 ALL SERVICES TO BE LOCATED AND VERIFIED BY THE BUILDER WITH THE RELEVANT AUTHORITIES PRIOR TO THE COMMENCEMMET OF ANY BUILDING.	В					
NOM ARCH J LIGADU NSW ARB NO 6549	MORFOSIS ARCHITECTS PTY LTD IS THE OWNER OF THE COPYRIGHT SUBSISTING IN THESE DRAWINGS, PLANS, DESIGN AND	A	DA ISSUE	14/12/23	C		
	SPECIFICATIONS. THEY MUST NOT BE USED, REPRODUCED, OR COPIED IN WHOLE OR IN PART NOR MAY THE INFORMATION, IDEAS AND CONCEPTS THEREIN CONTAINED BE DISCLOSED TO ANY PERSON WITHOUT PRIOR WRITTEN CONSENT OF THE OWNER.	ISSUE	AMENDMENTS	DATE	U		

SCALE	
As indicated @ A3	

DRAWING NUMBER:

DA-214 DRAWING TITLE: DETAILED PLAN - LVL 03

BUILDING

PROJECT



FCL	FOLDING CLOTHELINES
NTR	NON-TRAFFICABLE ROOF
P.O.S	PRIVATE OPEN SPACE
BG	BOX GUTTER
PS	PRIVACY SCREENS
GT	GARDEN TAP
	*OPERABLE WINDOWS ARE AWNING UNLESS NOTED OTHERWISE
HL	HI-LIGHT WINDOWS - MINIMUM 1.5M SILL HEIGHT
SLW	SLIDING WINDOWS - SILL HEIGHT BELOW 1.5M SHALL BE PROVIDED WITH RESTRICTOR TO ALLOW MAX 125MM DIA. SPHERE OPENING AS PER NCC (APPLICABLE TO LEVEL 1 & ABOVE WINDOWS)
GL	GLASS LOUVRE WINDOW
AC	A/C CONDENSER UNIT WITH SLAT SCREEN ENSLOSURE 1.1M H. REFER DETAIL
	STRUCTURAL ROOT ZONE
	TREE PROTECTION ZONE
	TREE TO BE REMOVED
	1 BEDROOM UNIT
	1 BEDROOM ADAPTABLE UNIT
	2 BEDROOM UNIT
	2 BEDROOM ADAPTABLE UNIT
	3 BEDROOM UNIT
	SHAFT
BC/ B	BIN CHUTE/ BINS ROOM
	LANDSCAPE

	GENERAL NOTES 1. ALL DIMENSIONS AND FLOOR AREAS TO BE VERIFIED BUILDIER PRIOR TO THE COMMENCEMENT OF ANY BUILDING WORK.				ISSUE	CLIENT	
MORFOSIS ARCHITECTS PTY LTE Suite 8 695 The Horsley Drive, Smithfield NSW 2164 ABN 44 609 593 473 P (02) 8712 5606 / F (02) 8712 5606 / M 0423777623 NOM ARCH J LIGADU NSW ARB NO 8549	2. ANY DESCREPANCIESW ARE TO BE CONFIRMEND BY THE DESIGNER. 3. LEVELS SHOWN ARE APPROXIMATE UNLESS ACCOMPANIED BY REDUCED LEVELS BY A REGISTERED SURVEYOR. 4. FIGURED DIMENSIONS ARE TO BE TAKEN IN PREFERENCE TO SCALING. 5. ALL BOUNDARY CLEARANCE MUST BE VERIFIED BY THE SURVEYOR PRIOR TO THE COMMENCEMENT OF ANY BUILDING WORK. 6. WHERE ENGINEERING OR HYDRAULIC DRAWINGS ARE REQUIRED, SUCH MUST TAKE PREFERENCE TO THIS DRAWING. 7. STORMWATER TO BE CONNECTED AND DISCHARGED TO COUNCL'S REQUIREMENTS AND TO AS 3500.3 8. ALL SERVICES TO BE LOCATED AND VERIFIED BY THE BUILDER WITH THE RELEVANT AUTHORITIES PRIOR TO THE COMMENCEMENT OF ANY BUILDING. MORFOSIS ARCHITECTS PTY LITD IS THE OWNER OF THE COPYRIGHT SUBSISTING IN THESE DRAWINGS, PLANS, DESIGN AND SPECIFICATIONS. THEY MUST NOT BE USED, REPRODUCED, OR COPIED IN WHOLE OR IN PART NOR MAY THE INFORMATION, IDEAS AND CONCEPTS THEREIN CONTAINED BE DISCLOSED TO ANY PERSON WITHOUT PRIOR WRITTEN CONSENT OF THE OWNER.	C B A ISSUE	DA ISSUE DEP COUNCIL RFI'S RESPONSE DA ISSUE AMENDMENTS	31/07/24 18/03/24 14/12/23 DATE	с	MCKAY MOOREBANK	

SCALE	
As indicated @ A3	

DRAWING NUMBER:

DA-215 DRAWING TITLE: DETAILED PLAN - LVL 04

PROJECT



	FCL	FOLDING CLOTHELINES
	NTR	NON-TRAFFICABLE ROOF
	P.O.S	PRIVATE OPEN SPACE
	BG	BOX GUTTER
	PS	PRIVACY SCREENS
	GT	GARDEN TAP
		*OPERABLE WINDOWS ARE AWNING UNLESS NOTED OTHERWISE
	HL	HI-LIGHT WINDOWS - MINIMUM 1.5M SILL HEIGHT
	SLW	SLIDING WINDOWS - SILL HEIGHT BELOW 1.5M SHALL BE PROVID WITH RESTRICTOR TO ALLOW MAX 125MM DI SPHERE OPENING AS PER NCC (APPLICABLE TO LEVEL 1 & ABOVE WINDOWS)
	GL	GLASS LOUVRE WINDOW
	AC	A/C CONDENSER UNIT WITH SLAT SCREEN ENSLOSURE 1.1M H. REFER DETAIL
		STRUCTURAL ROOT ZONE
		TREE PROTECTION ZONE
_		TREE TO BE REMOVED
		1 BEDROOM UNIT
		1 BEDROOM ADAPTABLE UNIT
		2 BEDROOM UNIT
		2 BEDROOM ADAPTABLE UNIT
		3 BEDROOM UNIT
		SHAFT
	BC/B	BIN CHUTE/ BINS ROOM
		LANDSCAPE


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MORFOSIS ARCHITECTS PTY LTD Suite 8 695 The Horsley Drive, Smithfield NSW 2164 ABN 44 609 593 473 P (02) 8712 5606 / F (02) 8712 5606 / M 0423777623 NOM ARCH J LIGADU NSW ARB NO 8549	3. LEVELS SHOWN ARE APPROXIMATE UNLESS ACCOMPANIED BY REDUCED LEVELS BY A REGISTERED SURVEYOR. 4. FIGURED DIMENSIONS ARE TO BE TAKEN IN PREFERENCE TO SCALING. 5. ALL BOUNDARY CLEARANCE MUST BE VERIFIED BY THE SURVEYOR PRIOR TO THE COMMENCEMENT OF ANY BUILDING WORK. 6. WHERE ENGINEERING OR HYDRAULIC DRAWINGS ARE REQUIRED, SUCH MUST TAKE PREFERENCE TO THIS DRAWING. 7. STORMWATER TO BE CONNECTED AND DISCHARGED TO COUNCIL'S REQUIREMENTS AND TO AS 300.3 8. ALL SERVICES TO BE LOCATED AND VERIFIED BY THE BUILDER WITH THE RELEVANT AUTHORITIES PRIOR TO THE COMMENCEMMET OF ANY BUILDING. MORFOSIS ARCHTECTS PTY LTD IS THE OWNER OF THE COPYRIGHT SUBSISTING IN THESE DRAWINGS, PLANS, DESIGN AND SPECIFICATIONS. THEY MUST NOT BE USED, REPRODUCED, OR COPIED IN WHOLE OR IN PART NOR MAY THE INFORMATION, IDEAS AND CONCEPTS THEREIN CONTAINED BE DISCLOSED TO ANY PRESON WITHOUT PRIOR WRITH OR CONTAINED	C B A ISSUE	DA ISSUE DEP COUNCIL RFI'S RESPONSE DA ISSUE AMENDMENTS	31/07/24 18/03/24 14/12/23 DATE	С	MCKAY MOOREBANK
	OWNER.					

SCALE	
As indicated @ A	43

DRAWING NUMBER:



PROJECT

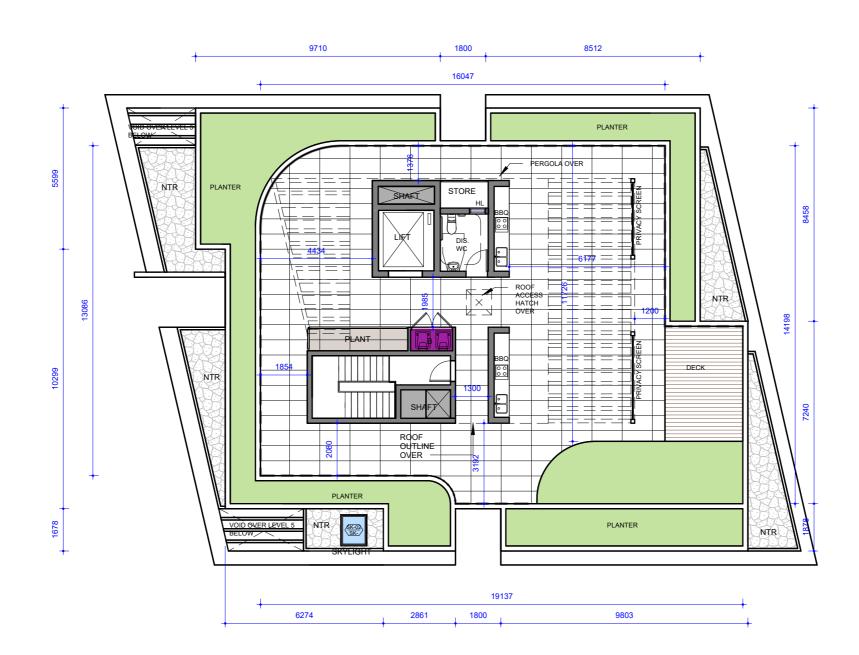


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DA-217 DRAWING TITLE: DETAILED PLAN - LEVEL 06


RESIDENTIAL FLAT BUILDING DEVELOPMENT AT 28 & 30 MCKAY AVENUE MOOREBANK

PROJECT



	GENERAL NOTES 1. ALL DIMENSIONS AND FLOOR AREAS TO BE VERIFIED BUILDIER PRIOR TO THE COMMENCEMENT OF ANY BUILDING WORK.				ISSUE	CLIENT
MORFOSIS ARCHITECTS PTY LTD Suite 8 695 The Horsley Drive, Smithfield NSW 2164 ABN 44 609 593 473 P (02) 8712 5606 / F (02) 8712 5606 / M 0423777623 NOM ARCH J LIGADU NSW ARB NO 8549	1. ALL DIMENSIONS AND FLOOR AREAS TO BE VERTIFIED BUILDIER FRIOR TO THE COMMENCEMENT OF ANY BUILDING WORK. 2. ANY DESCREPANCIESW ARE TO BE CONFIRMEND BY THE DESIGNER. 3. LEVELS SHOWN ARE APPROXIMATE UNLESS ACCOMPANIED BY REDUCED LEVELS BY A REGISTERED SURVEYOR. 4. FIGURED DIMENSIONS ARE TO BE TAKEN IN PREFERENCE TO SCALING. 5. ALL BOUNDARY CLEARANCE MUST BE VERIFIED BY THE SURVEYOR PRIOR TO THE COMMENCEMENT OF ANY BUILDING WORK. 6. WHERE ENGINEERING OR HYDRAULIC DRAWINGS ARE REGOURED, SUCH MUST TAKE PREFERENCE TO THIS DRAWING. 7. STORMWATER TO BE CONNECTED AND DISCHARGED TO COUNCIL'S REQUIREMENTS AND TO AS 3500.3 8. ALL SERVICES TO BE LOCATED AND VERIFIED BY THE BUILDER WITH THE RELEVANT AUTHORITIES PRIOR TO THE COMMENCEMNET OF ANY BUILDING.	C B	DA ISSUE DEP COUNCIL RFI'S RESPONSE	31/07/24 18/03/24		MCKAY MOOREBANK
	MORFOSIS ARCHITECTS PTY LTD IS THE OWNER OF THE COPYRIGHT SUBSISTING IN THESE DRAWINGS, PLANS, DESIGN AND SPECIFICATIONS, THEY MUST NOT BE USED, REPRODUCED, OR COPIED IN WHOLE OR IN PART NOR MAY THE INFORMATION, IDEAS AND CONCEPTS THEREIN CONTAINED BE DISCLOSED TO ANY PERSON WITHOUT PRIOR WRITTEN CONSENT OF THE OWNER.	ISSUE AMENDMENTS DATE	C			

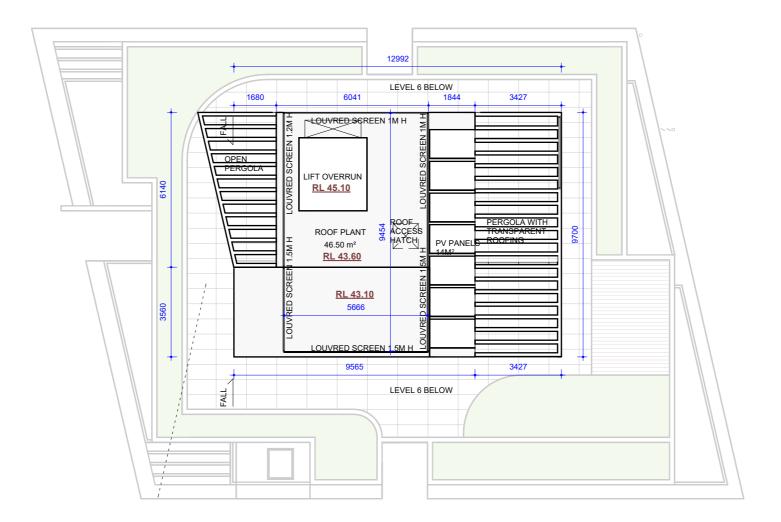DRAWING NUMBER:	PROJECT
DA-218	
DRAWING TITLE:	RESIDENTIAL FLAT
DETAILED PLAN - ROOF	BUILDING
SCALE	
	MOOREBANK
1 : 150 @ A3	
DRAWING TITLE: DETAILED PLAN - ROOF	

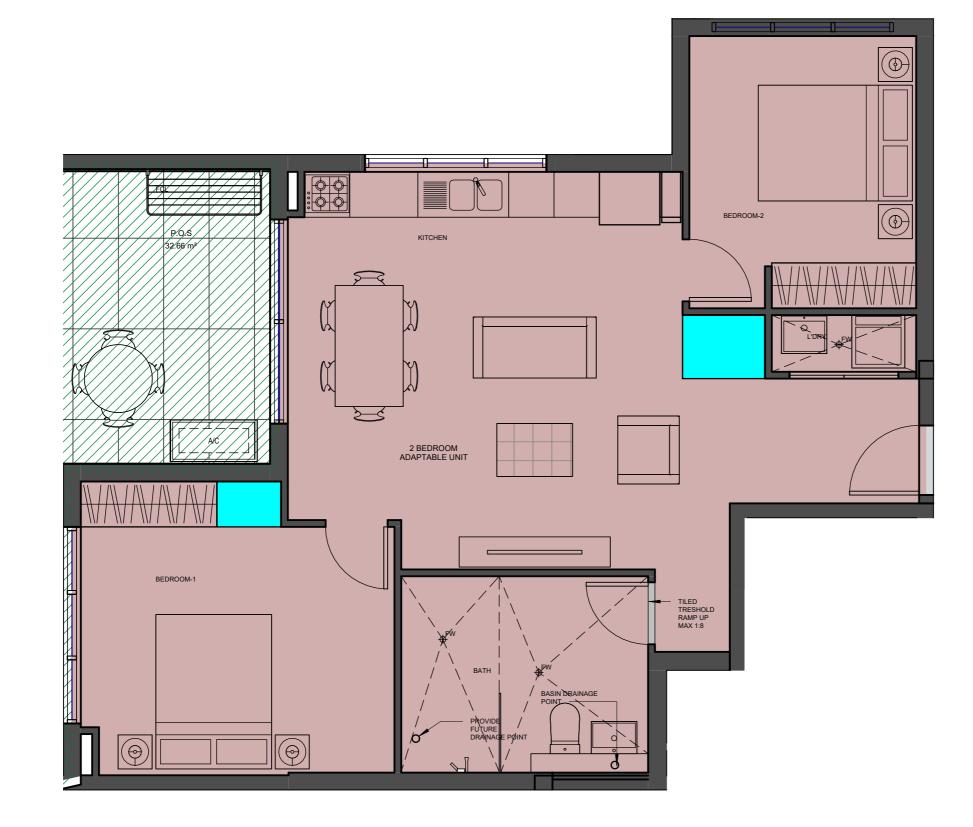


MORFOSIS ARCHITECTS PTY LTD

Suite 8 695 The Horsley Drive, Smithfield NSW 2164 ABN 44 609 593 473 P (02) 8712 5606 / F (02) 8712 5606 / M 0423777623 NOM ARCH J LIGADU NSW ARB NO 8549

GENERAL NOTES

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C DA ISSUE 31/07/24 B DEP COUNCIL RFI'S RESPONSE 18/03/24 ISSUE AMENDMENTS DATE	ISSUE	CLIENT MCKAY MOOREBANK	DRAWING NUMBER: DA-221 DRAWING TITLE: ADAPTABLE UNIT TYPE A PRE ADAPTION SCALE 1 : 50 @ A3	PROJECT RESIDENTIAL FLAT BUILDING DEVELOPMENT AT 28 & 30 MCKAY AVENUE MOOREBANK
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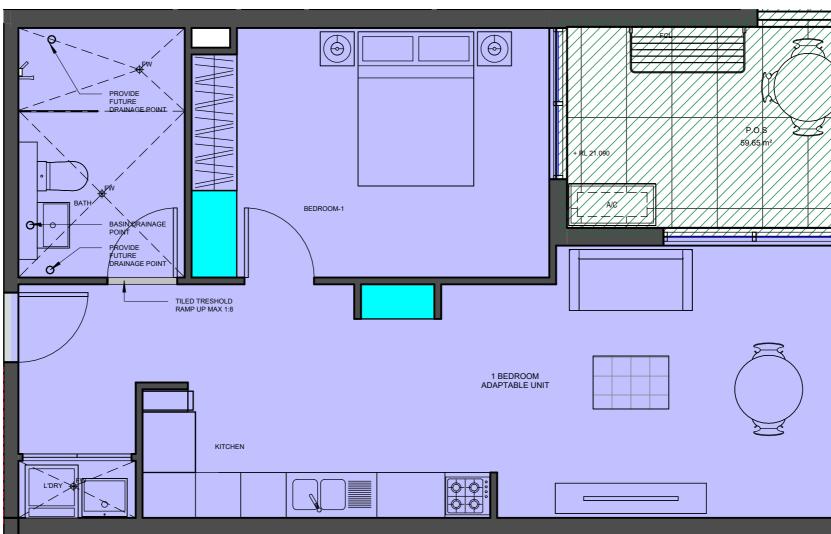
MORFOSIS ARCHITECTS PTY LTD

Suite 8 695 The Horsley Drive, Smithfield NSW 2164 ABN 44 609 593 473 P (02) 8712 5606 / F (02) 8712 5606 / M 0423777623 NOM ARCH J LIGADU NSW ARB NO 8549

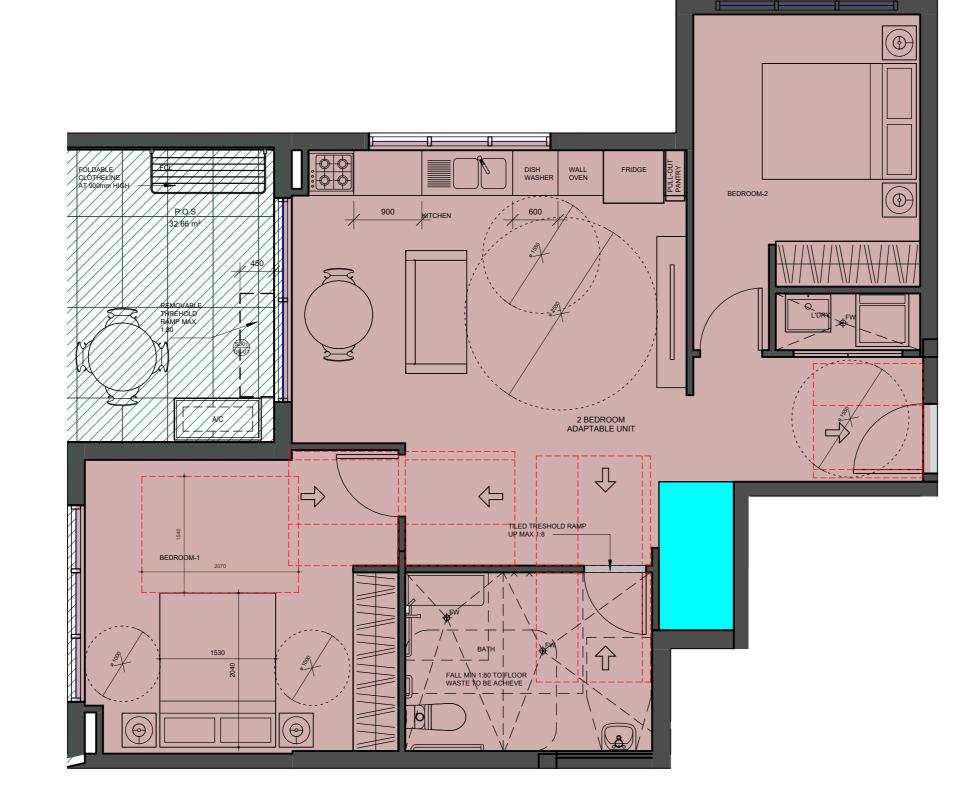GENERAL NOTES


GENERAL NOTES 1. ALL DIMENSIONS AND FLOOR AREAS TO BE VERIFIED BUILDIER PRIOR TO THE COMMENCEMENT OF ANY BUILDING WORK. 2. ANY DESCREPANCIESW ARE TO BE CONFIRMEND BY THE DESIGNER. 3. LEVELS SHOWN ARE APPROXIMATE UNLESS ACCOMPANIED BY REDUCED LEVELS BY A REGISTERED SURVEYOR. 4. FIGURED DIMENSIONS ARE TO BE TAKEN IN PREFERENCE TO SCALING. 5. ALL BOUNDARY CLEARANCE MUST BE VERIFIED BY THE SURVEYOR PRIOR TO THE COMMENCEMENT OF ANY BUILDING WORK. 6. WHERE ENGINEERING OR HYDRAULIC DRAWINGS ARE REQUIRED, SUCH MUST TAKE PREFERENCE TO THIS DRAWING. 7. STORMWATER TO BE CONNECTED AND DISCHARGED TO COUNCL'S REQUIREMENTS AND TO AS 3500.3 8. ALL SERVICES TO BE LOCATED AND VERIFIED BY THE BUILDEW WITH THE RELEVANT AUTHORITIES PRIOR TO THE COMMENCEMNET OF ANY BUILDING. MORFOSIS ARCHITECTS PTV LTD IS THE OWNER OF THE COPYRIGHT SUBSISTING IN THESE DRAWINGS, PLANS, DESIGN AND SPECIFICATIONS. THEY MUST NOT BE USED, REPRODUCED, OR COPIED IN WHOLE ON ARY THE INFORMATION, IDEAS AND CONCEPTS THEREIN CONTAINED BE DISCLOSED TO ANY PERSON WITHOUT PRIOR WRITTEN CONSENT OF THE OWNER.

C B	DA ISSUE DEP COUNCIL RFI'S RESPONSE	31/07/24 18/03/24	ISSUE	CLIENT MCKAY MOOREBANK	DRAWING NUMBER: DA-222 DRAWING TITLE: ADAPTABLE UNIT TYPE A POST ADAPTION SCALE	PROJECT RESIDENTIAL FLAT BUILDING DEVELOPMENT AT 28 & 30 MCKAY AVENUE MOOREBANK
ISSUE	AMENDMENTS	DATE	0		1 : 50 @ A3	




MORFOSIS ARCHITECTS PTUTD ISSUE CLIENT DRAWING NUMBER: DA-223 NUMBER: DA-223 DA-223 DRAWING TITLE: DA-223 Suite 8 695 The Horsley Drive, Smithfield NSW 2164 ABN 44 609 593 473 Iscues Show Area PPROXIMATE UNLESS ACCOMPANIED BY THE DESIGNER: DRAWING NUMBER: DRAWING TITLE: DA-223 P (02) 8712 5606 / F (02) 8712 5606 / M 0423777623 NOM ARCH J LIGADU NSW ARB NO 8549 Scale Boundered by the comprised by the comprised by the comprised by the comprised part nor max to max the information, specifications, they must not be used, network of the comprised part nor max to max to max the information, specifications and concepts therein contained be the soluced on the comprised part nor max to max to max the information, specifications and concepts therein contained be preserved to the soluce on the comprised part nor max to max the information, so the preservice to and building work. C DA ISUE All DIB Comprised by the soluce on the comax to max to max to max to max to max to max
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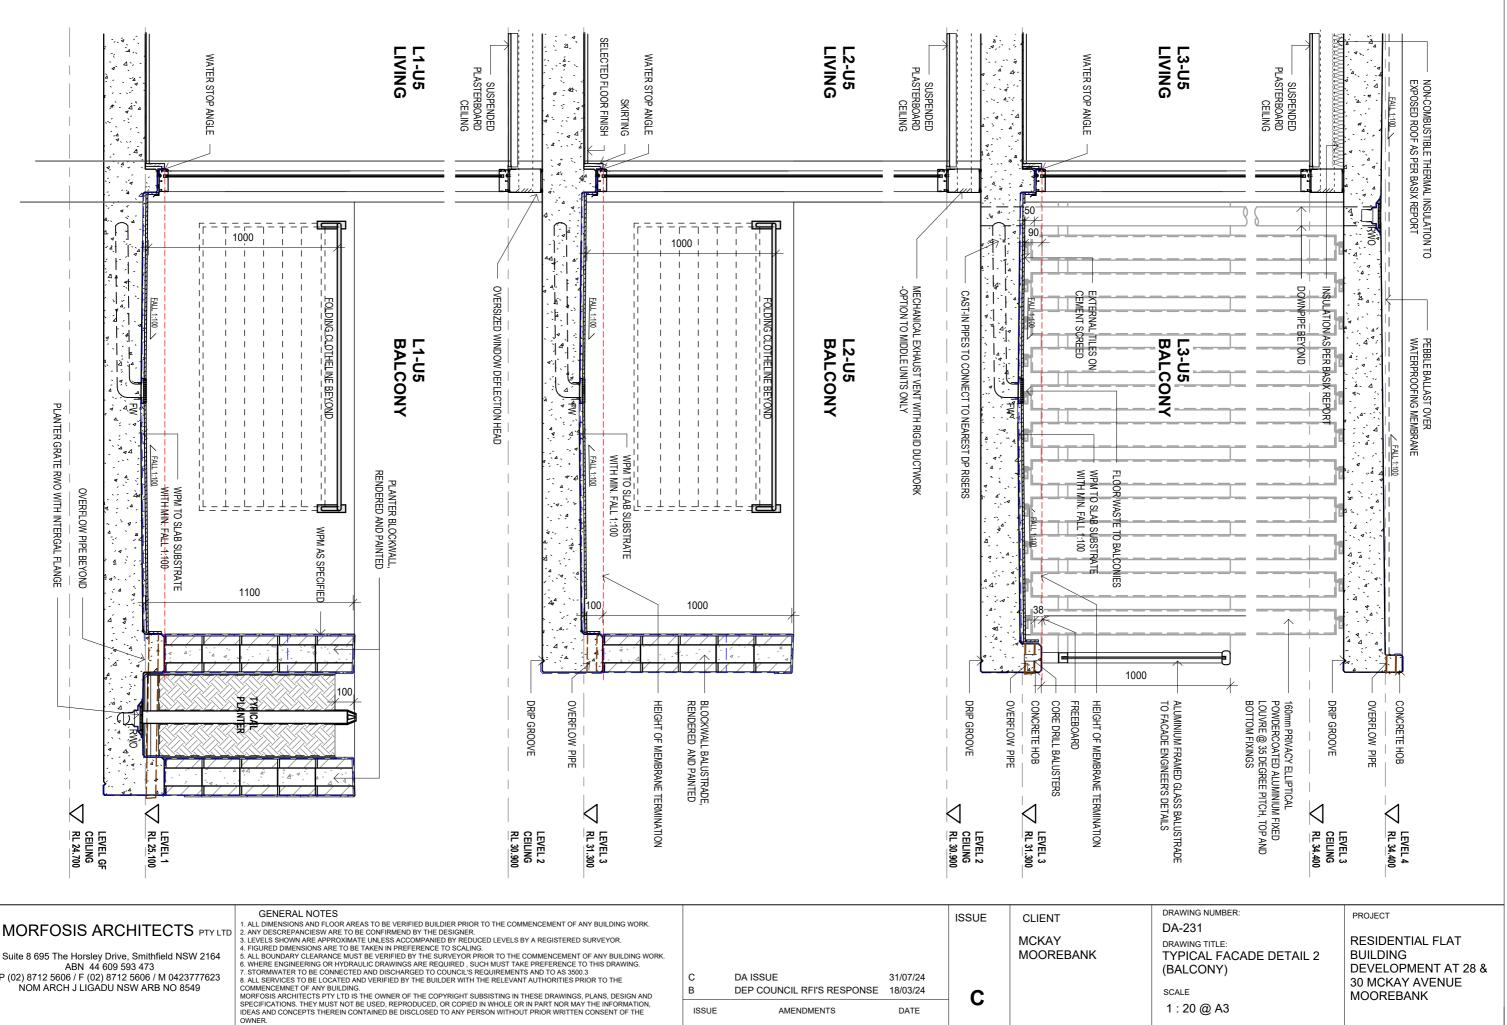


MORFOSIS ARCHITECTS PTY LTD Suite 8 695 The Horsley Drive, Smithfield NSW 2164 ABN 44 609 593 473 P (02) 8712 5606 / F (02) 8712 5606 / M 0423777623 NOM ARCH J LIGADU NSW ARB NO 8549	GENERAL NOTES 1. ALL DIMENSIONS AND FLOOR AREAS TO BE VERIFIED BUILDIER PRIOR TO THE COMMENCEMENT OF ANY BUILDING WORK. 2. ANY DESCREPANCIESW ARE TO BE CONFIRMEND BY THE DESIGNER. 3. LEVELS SHOWN ARE APPROXIMATE UNLESS ACCOMPANIED BY REDUCED LEVELS BY A REGISTERED SURVEYOR. 4. FIGURED DIMENSIONS ARE TO BE TAKEN IN PREFERENCE TO SCALING. 5. ALL BOUNDARY CLEARANCE MUST BE VERIFIED BY THE SURVEYOR PRIOR TO THE COMMENCEMENT OF ANY BUILDING WORK. 6. WHERE ENGINEERING OR HYDRAULIC DRAWINGS ARE REQUIRED, SUCH MUST TAKE PREFERENCE TO THIS DRAWING. 7. STORMWATER TO BE CONFECTED AND DISCHARGED TO COUNCL'S REQUIREMENTS AND TO AS 3500.3 8. ALL SERVICES TO BE LOCATED AND VERIFIED BY THE BUILDER WITH THE RELEVANT AUTHORITIES PRIOR TO THE COMMENCEMINE OF ANY BUILDING. MORFOSIS ARCHITECTS PTY LTD IS THE OWNER OF THE COPYRIGHT SUBSISTING IN THESE DRAWINGS, PLANS, DESIGN AND SPECIFICATIONS. THEY MUST NOT BE USED, REPRODUCED, OR COPIED IN WHOLE OR IN PART NOR MAY THE INFORMATION, IDEAS AND CONCEPTS THEREIN CONTAINED BE DISCLOSED TO ANY PERSON WITHOUT PRIOR WRITH OCONSENT OF THE	C B ISSUE	DA ISSUE DEP COUNCIL RFI'S RESPONSE AMENDMENTS	31/07/24 18/03/24 DATE	ISSUE C	CLIENT MCKAY MOOREBANK	DRAWING NUMBER: DA-224 DRAWING TITLE: ADAPTABLE UNIT TYPE B POST ADAPTION SCALE 1 : 50 @ A3	PROJECT RESIDENTIAL FLAT BUILDING DEVELOPMENT AT 28 8 30 MCKAY AVENUE MOOREBANK
	OWNER.							

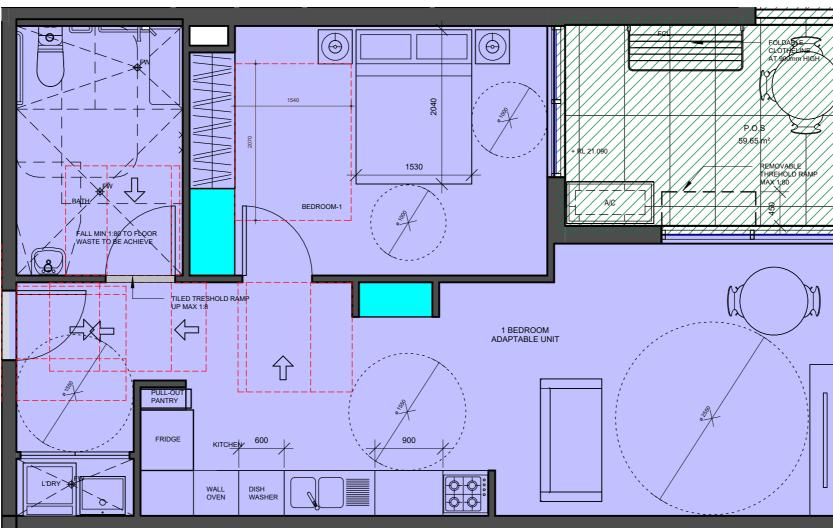






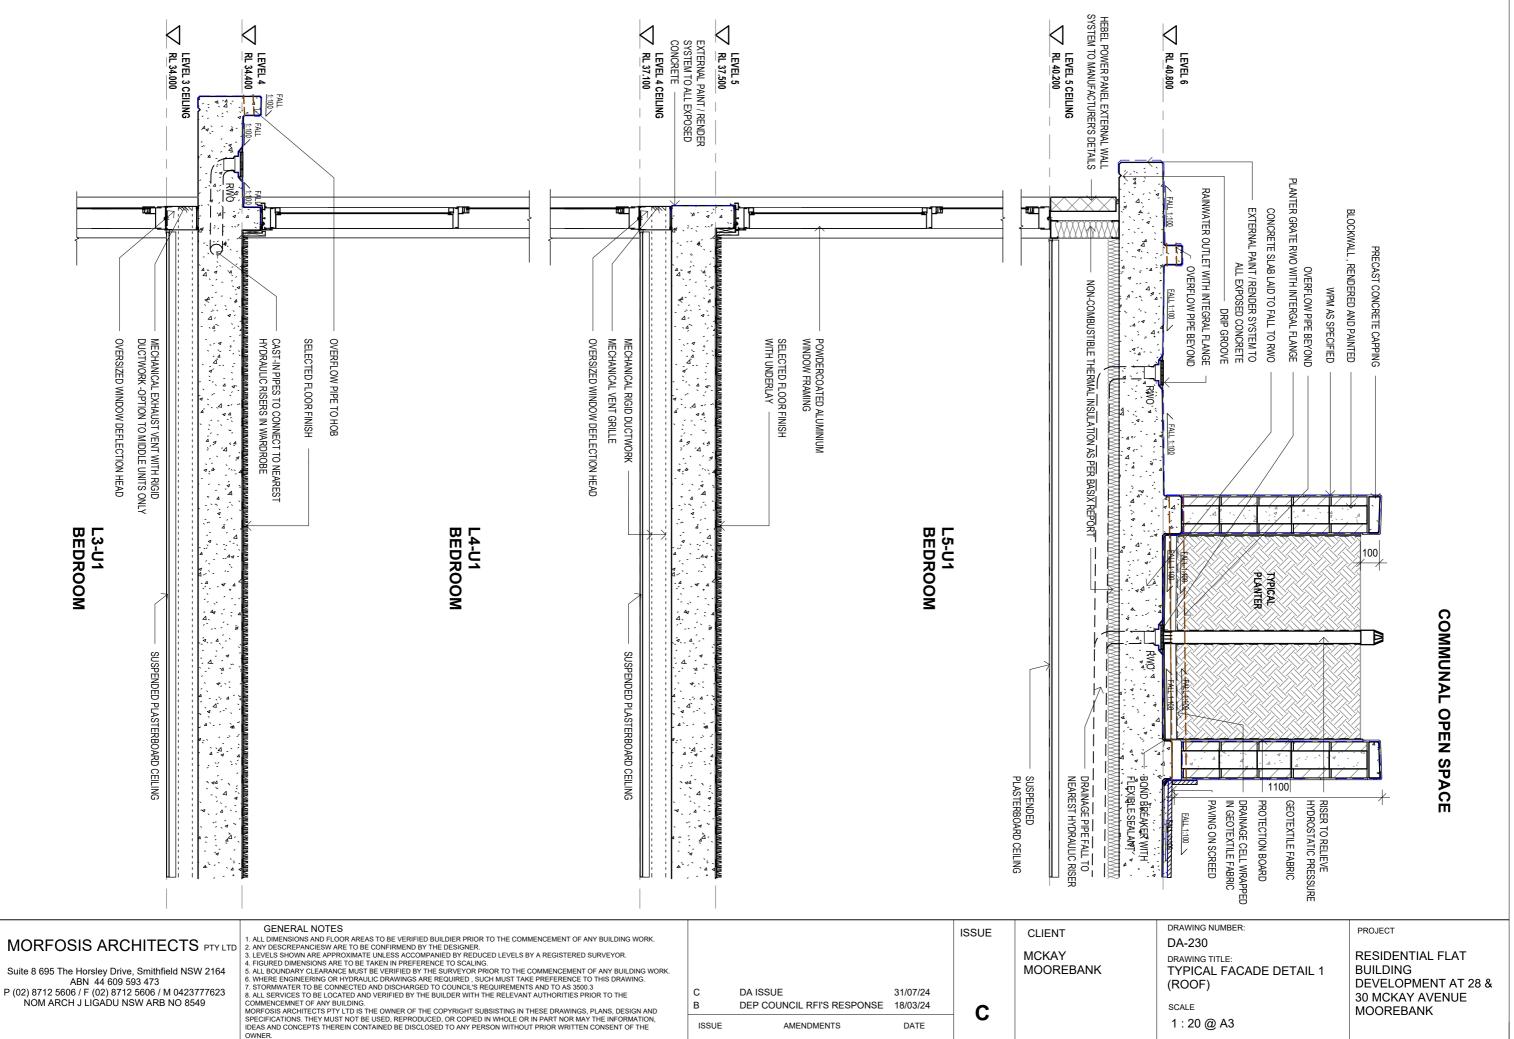

P (02) 8712 5606 / F (02) 8712 5606 / M 0423777623

			ISSUE	CLIENT	
				MCKAY MOOREBANK	
С	DA ISSUE	31/07/24			(
В	DEP COUNCIL RFI'S RESPONSE	18/03/24	С		
ISSUE	AMENDMENTS	DATE			
-					

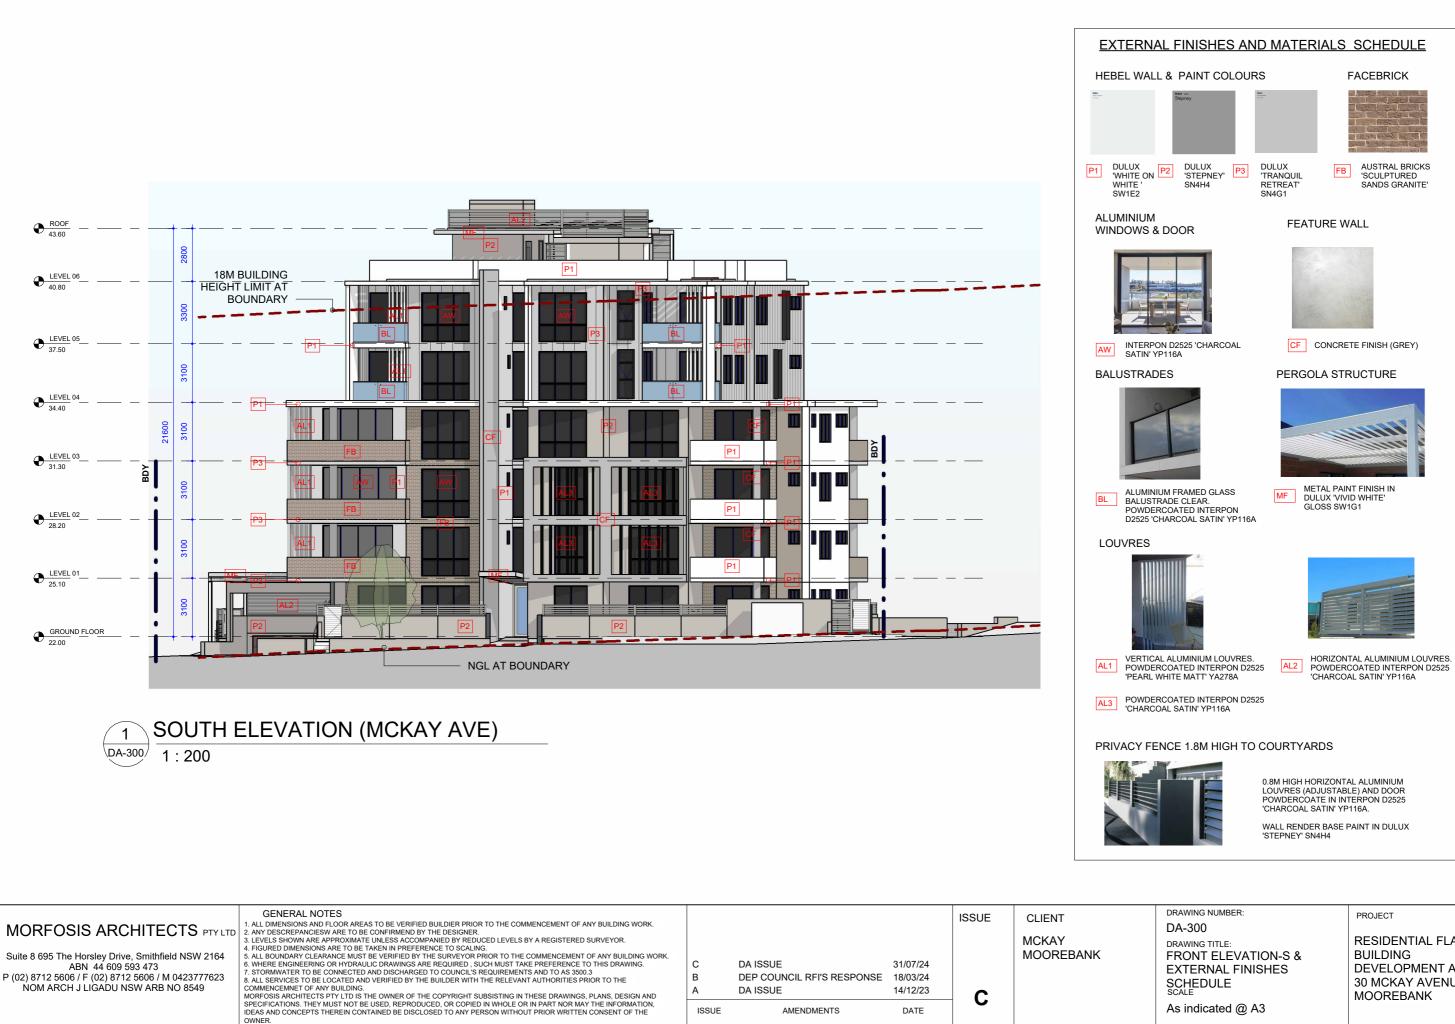

RESIDENTIAL FLAT DEVELOPMENT AT 28 & 30 MCKAY AVENUE





MORFOSIS ARCHITECTS PTY LTD Suite 8 695 The Horsley Drive, Smithfield NSW 2164 ABN 44 609 593 473 P (02) 8712 5606 / F (02) 8712 5606 / M 0423777623 NOM ARCH J LIGADU NSW ARB NO 8549	GENERAL NOTES 1. ALL DIMENSIONS AND FLOOR AREAS TO BE VERIFIED BUILDIER PRIOR TO THE COMMENCEMENT OF ANY BUILDING WORK. 2. ANY DESCREPANCIESW ARE TO BE CONFIRMEND BY THE DESIGNER. 3. LEVELS SHOWN ARE APPROXIMATE UNLESS ACCOMPANIED BY REDUCED LEVELS BY A REGISTERED SURVEYOR. 4. FIGURED DIMENSIONS ARE TO BE TAKEN IN PREFERENCE TO SCALING. 5. ALL BOUNDARY CLEARANCE MUST BE VERIFIED BY THE SURVEYOR PRIOR TO THE COMMENCEMENT OF ANY BUILDING WORK. 6. WHERE ENGINEERING OR HYDRAULIC DRAWINGS ARE REQUIRED, SUCH MUST TAKE PREFERENCE TO THIS DRAWING. 7. STORMWATER TO BE CONNECTED AND DISCHARGED TO COUNCL'S REQUIREMENTS AND TO AS 350.3 8. ALL SERVICES TO BE LOCATED AND VERIFIED BY THE BUILDER WITH THE RELEVANT AUTHORITIES PRIOR TO THE COMMENCEMENT OF ANY BUILDING. MORFOSIS ARCHITECTS PTY LID IS THE OWNER OF THE COPYRIGHT SUBSISTING IN THESE DRAWINGS, PLANS, DESIGN AND SPECIFICATIONS. THEY MUST NOT BE USED, REPRODUCED, OR COPIED IN WHOLE OR IN PART NOR MAY THE INFORMATION, IDEAS AND CONCEPTS THEREIN CONTAINED BE DISCLOSED TO ANY PERSON WITHOUT PRIOR WRITTEN CONSENT OF THE OWNER.	C B ISSUE	DA ISSUE DEP COUNCIL RFI'S RESPONSE AMENDMENTS	31/07/24 18/03/24 DATE	ISSUE C	CLIENT MCKAY MOOREBANK

scale 1 : 200 @ A3

DRAWING NUMBER: DA-301 DRAWING TITLE: REAR ELEVATION -N

PROJECT






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scale 1 : 200 @ A3

DRAWING NUMBER: DA-302 DRAWING TITLE: SIDE ELEVATION -E

PROJECT

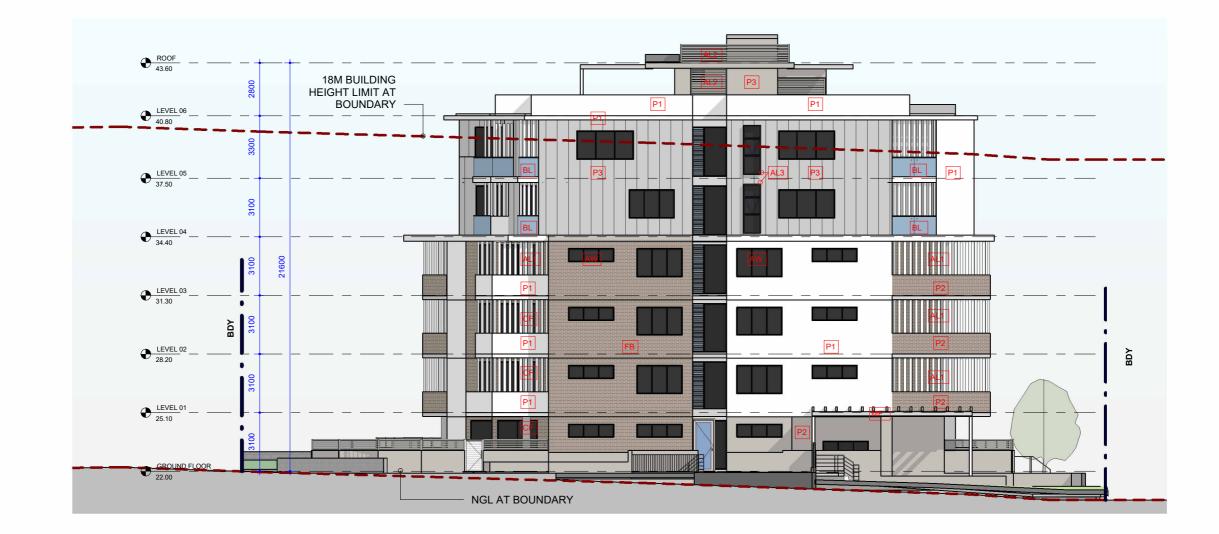


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scale 1 : 200 @ A3

DRAWING NUMBER: DA-303 DRAWING TITLE: SIDE ELEVATION -W

PROJECT

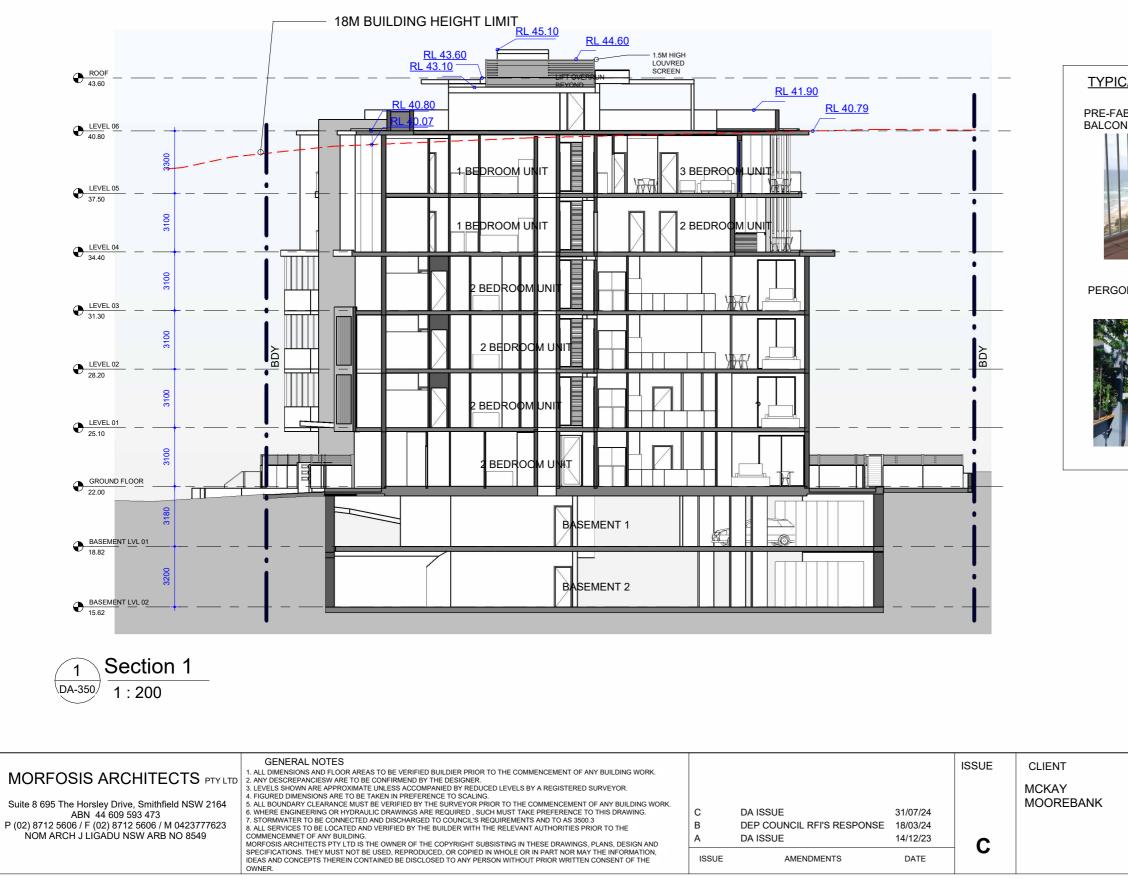

DA ISSUE

AMENDMENTS

А

ISSUE

14/12/23

DATE

С

NOM ARCH J LÌGADU NSW ARB NO 8549

TYPICAL DETAILS

BALCONIES/ COURTYARDS



PRE-FABRICATED 1M HIGH BOXED A/C SCREENING TO




PERGOLA WITH WIRE GRID ROOF





VERTICALCABLE TENSIONED WIRE IN BETWEEN STEEL COLUMNS WITHIN INSITU CONCRETE FINISH PLANTERS


PAINTED STRUCTURAL STEEL FRAMING PERGOLA OVER WITH INFILL WIRE GRID ROOF TO MANUFACTURER'S DETAILS

DRAWING NUMBER: PROJECT DA-350 **RESIDENTIAL FLAT** DRAWING TITLE: SECTIONS BUILDING DEVELOPMENT AT 28 & 30 MCKAY AVENUE MOOREBANK SCALE As indicated @ A3

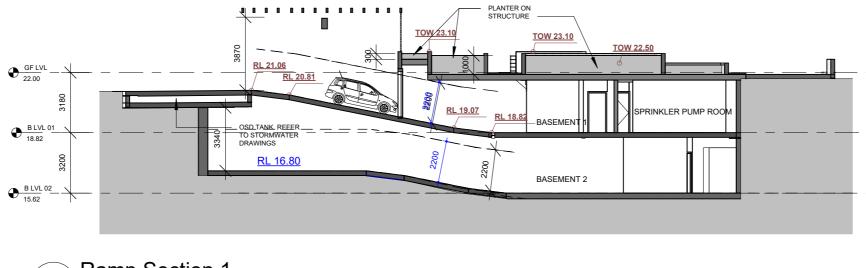

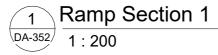

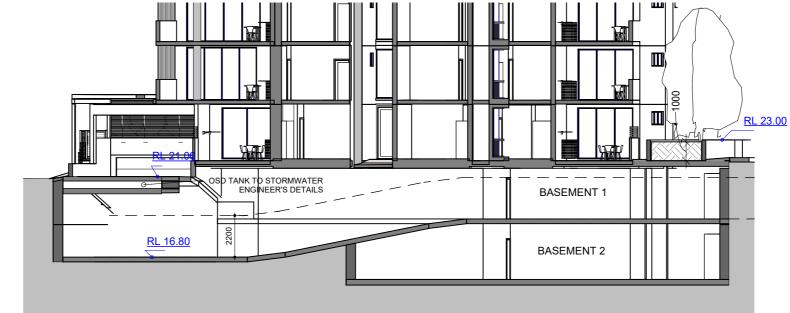

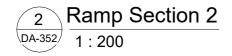

	GENERAL NOTES				ISSUE	CLIENT	Τ
MORFOSIS ARCHITECTS PTY LTI Suite 8 695 The Horsley Drive, Smithfield NSW 2164 ABN 44 609 593 473 P (02) 8712 5606 / F (02) 8712 5606 / M 0423777623 NOM ARCH J LIGADU NSW ARB NO 8549	1. ALL DIMENSIONS AND FLOOR AREAS TO BE VERIFIED BUILDIER PRIOR TO THE COMMENCEMENT OF ANY BUILDING WORK. 2. ANY DESCREPANCIESW ARE TO BE CONFIRMEND BY THE DESIGNER. 3. LEVELS SHOWN ARE APPROXIMATE UNLESS ACCOMPANIED BY REDUCED LEVELS BY A REGISTERED SURVEYOR. 4. FIGURED DIMENSIONS ARE TO BE TAKEN IN PREFERENCE TO SCALING. 5. ALL BOUNDARY CLEARANCE MUST BE VERIFIED BY THE SURVEYOR PRIOR TO THE COMMENCEMENT OF ANY BUILDING WORK. 6. WHERE ENGINEERING OR HYDRAULIC DRAWINGS ARE REQUIRED, SUCH MUST TAKE PREFERENCE TO THIS DRAWING. 7. STORMWATER TO BE CONNECTED AND DISCHARGED TO COUNCIL'S REQUIREMENTS AND TO AS 3500.3 8. ALL SERVICES TO BE LOCATED AND VERIFIED BY THE BUILDER WITH THE RELEVANT AUTHORITIES PRIOR TO THE COMMENCEMINET OF ANY BUILDING. MORFOSIS ARCHTECTS PTY LID IS THE OWNER OF THE COPYRIGHT SUBSISTING IN THESE DRAWINGS, PLANS, DESIGN AND SPECIFICATIONS, THEY MUST NOT BE USED, REPRODUCED, OR COPIED IN WHOLE OR IN PART NOR MAY THE INFORMATION, IDEAS AND CONCEPTS THRERIN CONTAINED BE DISCLOSED TO ANY PERSON WITHOUT PRIOR WRITTEN CONSENT OF THE OWNER.	C B A ISSUE	DA ISSUE DEP COUNCIL RFI'S RESPONSE DA ISSUE AMENDMENTS	31/07/24 18/03/24 14/12/23 DATE	- C	MCKAY MOOREBANK	


SC	ALE			
1	: 20	00	@	A3

DA-352 DRAWING TITLE: RAMP SECTIONS

DRAWING NUMBER:

RESIDENTIAL FLAT BUILDING DEVELOPMENT AT 28 & 30 MCKAY AVENUE MOOREBANK

PROJECT

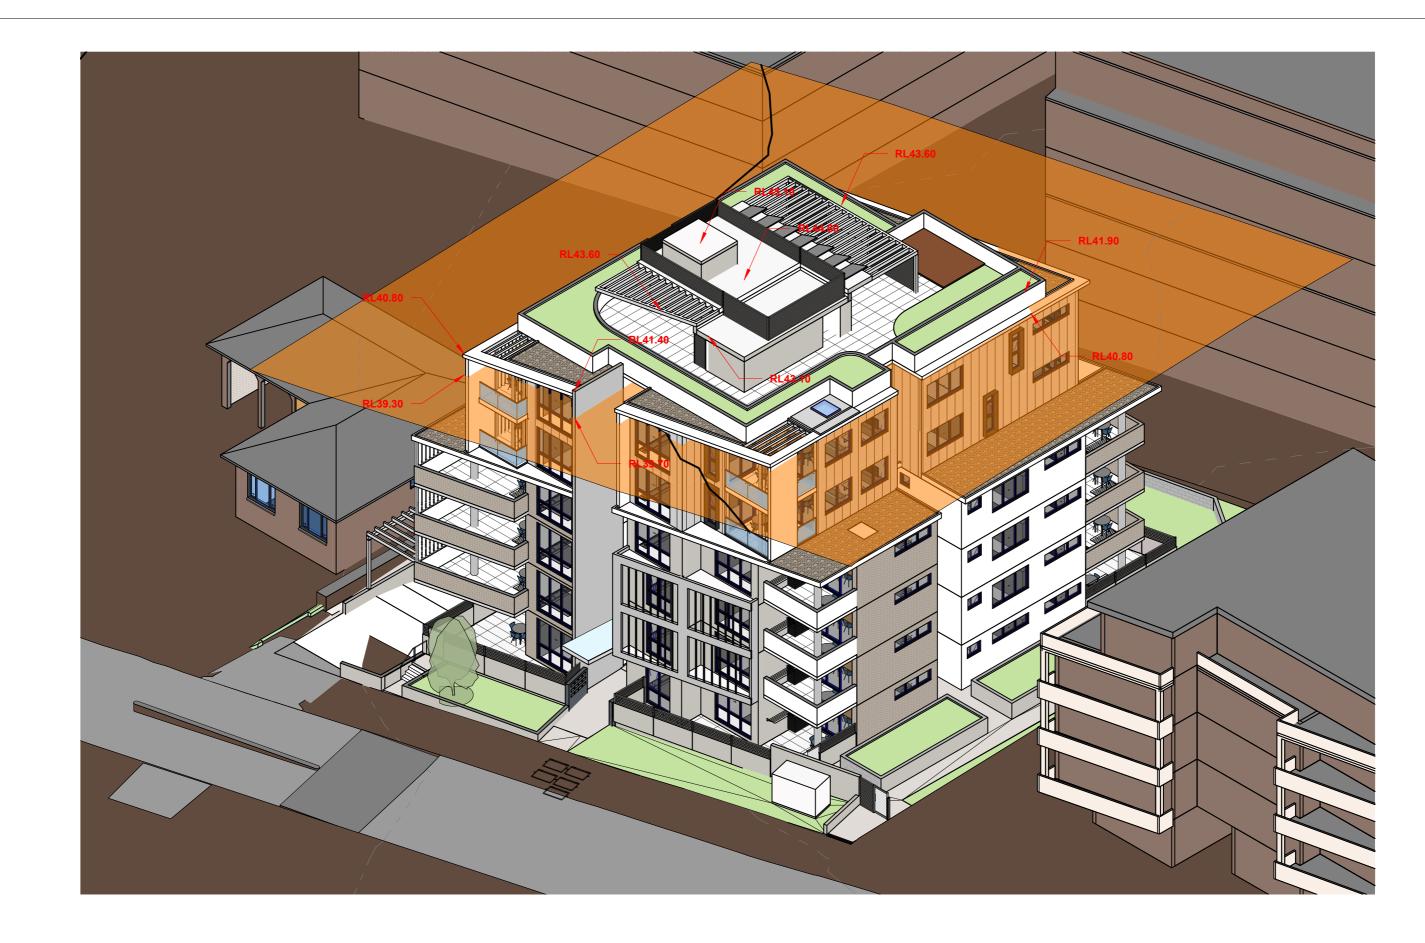

MORFOSIS ARCHITECTS PTY LTD	1.
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Suite 8 695 The Horsley Drive, Smithfield NSW 2164 ABN 44 609 593 473 P (02) 8712 5606 / F (02) 8712 5606 / M 0423777623 NOM ARCH J LIGADU NSW ARB NO 8549

GENERAL NOTES

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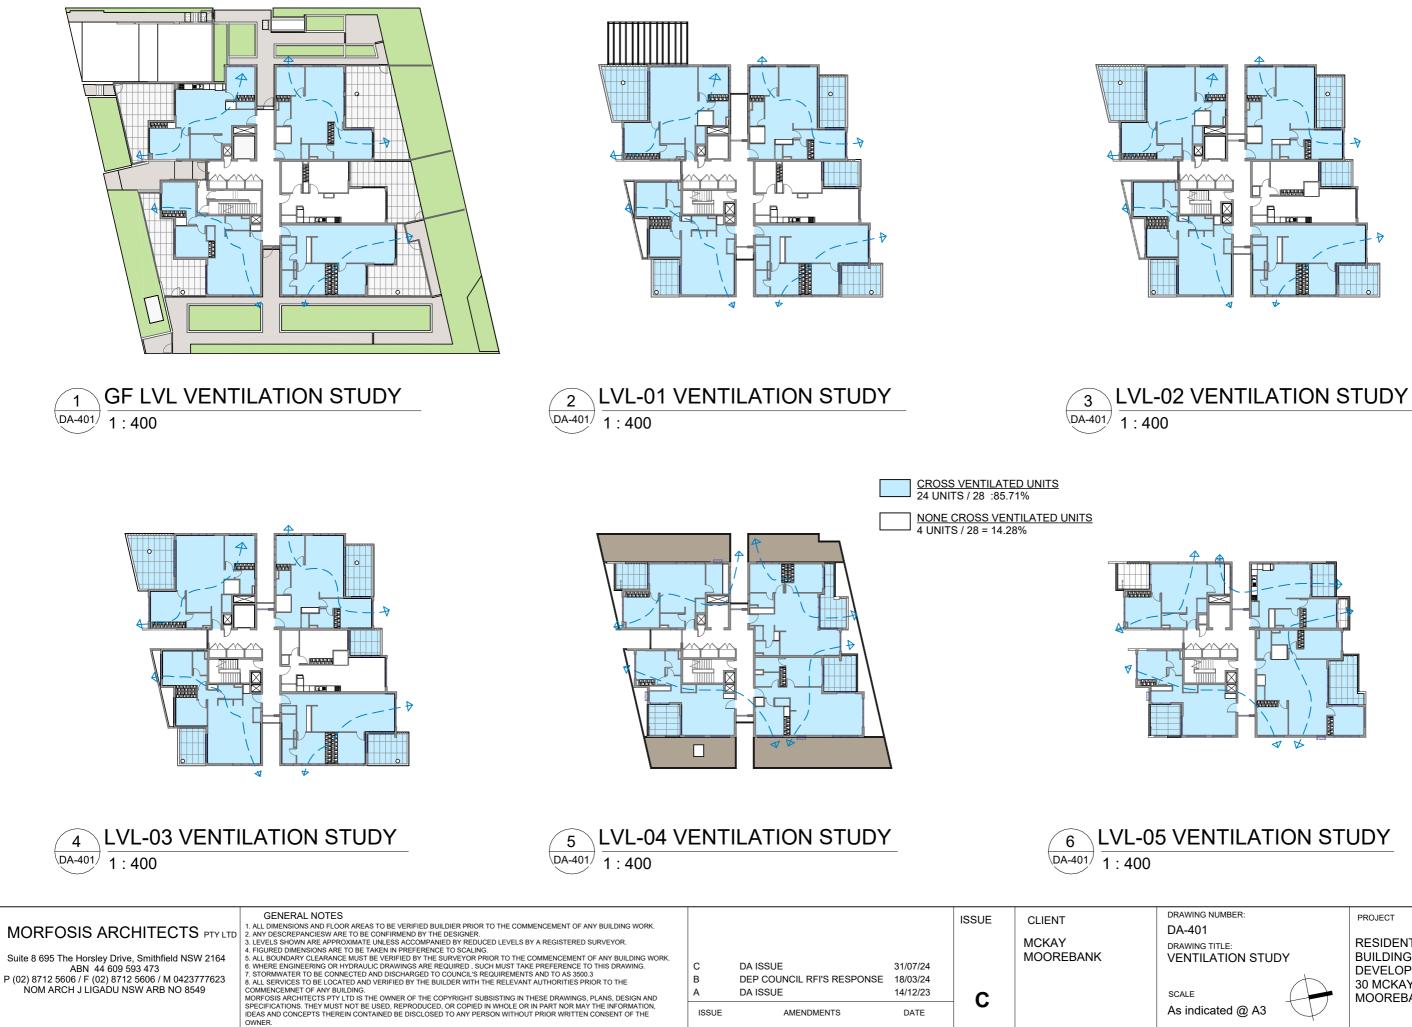
			ISSUE	CLIENT
С	DA ISSUE	31/07/24		MCKAY MOOREBANK
В	DEP COUNCIL RFI'S RESPONSE	18/03/24		
Α	DA ISSUE	14/12/23	С	
ISSUE	AMENDMENTS	DATE		

SCALE @ A3

DRAWING NUMBER:

DA-400 DRAWING TITLE: BUILDING HEIGHT PLANE 3D

PROJECT



DA ISSUE

AMENDMENTS

Α

OWNER.

ISSUE

14/12/23

DATE

С

RESIDENTIAL FLAT BUILDING DEVELOPMENT AT 28 & 30 MCKAY AVENUE MOOREBANK

SCALE As indicated @ A3





PROJECT

RESIDENTIAL FLAT BUILDING DEVELOPMENT AT 28 & 30 MCKAY AVENUE MOOREBANK

STORAGE CALCULATION

Mark	VOLUME	Level	Comments	
SL-U1	4.90 m ³	B LVL 01	EXTERNAL STORAGE	
GL-U1 GL-U1	1.48 m ³	GF LVL	INTERNAL STORAG	
GL-U1 GL-U1	2.66 m ³	GF LVL	INTERNAL STORAGE	
GL-UT	9.03 m ³	GFLVL	INTERNAL STORAGE	
GL-U2	4.90 m ³	B LVL 01	EXTERNAL STORAGE	
GL-U2	1.94 m ³	GF LVL	INTERNAL STORAGE	
GL-U2	2.73 m ³	GF LVL	INTERNAL STORAGE	
	9.57 m ³	1		
GL-U3	3.93 m ³	GF LVL	INTERNAL STORAGE	
GL-U3	4.90 m ³	B LVL 01	EXTERNAL STORAGE	
	8.83 m ³			
GL-U4	8.57 m ³	B LVL 01	EXTERNAL STORAGE	
GL-U4	1.29 m ³	GF LVL	INTERNAL STORAGE	
	9.86 m ³	I		
GL-U5	7.90 m ³	GF LVL	INTERNAL STORAGE	
GL-U5	4.90 m ³	B LVL 01	EXTERNAL STORAGE	
	12.79 m ³	1	1	
L1-U1	4.61 m ³	B LVL 01	EXTERNAL STORAGE	
L1-U1	7.07 m ³	LVL 01	INTERNAL STORAGE	
	11.68 m ³	1	-	
L1-U2	8.06 m ³	B LVL 01	EXTERNAL STORAGE	
L1-U2	1.61 m ³	LVL 01	INTERNAL STORAGE	
L1-U2	1.90 m ³	LVL 01	INTERNAL STORAGE	
	11.58 m ³	1	1	
L1-U3	3.93 m ³	LVL 01	INTERNAL STORAGE	
L1-U3	8.57 m ³	B LVL 01	EXTERNAL STORAGE	
	12.50 m ³	•		
L1-U4	1.29 m ³	LVL 01	INTERNAL STORAGE	
L1-U4	8.57 m ³	B LVL 01	EXTERNAL STORAGE	
L1-U4	2.00 m ³	LVL 01	INTERNAL STORAGE	
	11.86 m ³			
L1-U5	7.90 m ³	LVL 01	INTERNAL STORAGE	
L1-U5	9.58 m ³	B LVL 01	EXTERNAL STORAGE	
L1-U5	2.72 m ³	LVL 01	INTERNAL STORAGE	
	20.19 m ³	· · · · · · · · · · · · · · · · · · ·		
L2-U1	7.07 m ³	LVL 02	INTERNAL STORAGE	
L2-U1	4.61 m ³	B LVL 01	EXTERNAL STORAGE	
	11.68 m ³			
L2-U2	5.78 m ³	B LVL 02	EXTERNAL STORAGE	
L2-U2	1.61 m ³	LVL 02	INTERNAL STORAGE	
L2-U2	1.90 m ³	LVL 02	INTERNAL STORAGE	
	9.29 m³			
L2-U3	3.93 m ³	LVL 02	INTERNAL STORAGE	
L2-U3	8.06 m ³	B LVL 02	EXTERNAL STORAGE	
	11.99 m ³			
L2-U4	8.57 m³	B LVL 02	EXTERNAL STORAGE	
L2-U4	6.62 m ³	LVL 02	INTERNAL STORAGE	
L2-U4	2.22 m ³	LVL 02	INTERNAL STORAGE	

	STOR	AGE CALC	ULATION
Mark	VOLUME	Level	Comments
	17.41 m ³		
L2-U5	7.90 m ³	LVL 02	INTERNAL STORAGE
L2-U5	8.57 m ³	B LVL 02	EXTERNAL STORAGE
L2-U5	2.73 m ³	LVL 02	INTERNAL STORAGE
	19.19 m³	I	
L3-U1	7.07 m ³	LVL 03	INTERNAL STORAGE
L3-U1	8.06 m ³	B LVL 02	EXTERNAL STORAGE
	15.13 m ³		
L3-U2	8.57 m ³	B LVL 02	EXTERNAL STORAGE
L3-U2	1.61 m ³	LVL 03	INTERNAL STORAGE
L3-U2	1.90 m ³	LVL 03	INTERNAL STORAGE
	12.08 m ³		
L3-U3	3.93 m ³	LVL 03	INTERNAL STORAGE
L3-U3	8.57 m ³	B LVL 02	EXTERNAL STORAGE
	12.50 m ³	1	
L3-U4	6.62 m ³	LVL 03	INTERNAL STORAGE
L3-U4	8.06 m ³	B LVL 02	EXTERNAL STORAGE
L3-U4	2.22 m ³	LVL 03	INTERNAL STORAGE
20 0 .	16.90 m ³	21200	
L3-U5	7.90 m ³	LVL 03	INTERNAL STORAGE
L3-U5	5.18 m ³	B LVL 02	EXTERNAL STORAGE
L3-U5	3.11 m ³	LVL 03	INTERNAL STORAGE
20-00	16.19 m ³		
L4-U1	5.53 m ³	LVL 04	INTERNAL STORAGE
L4-U1	4.61 m ³	B LVL 02	EXTERNAL STORAGE
L+-01	10.14 m ³	DLVL02	
L4-U2	3.22 m ³	LVL 04	INTERNAL STORAGE
L4-U2	4.90 m ³	B LVL 02	EXTERNAL STORAGE
L4-U2	1.69 m ³	LVL 04	INTERNAL STORAGE
L4-U2	1.46 m ³	LVL 04	INTERNAL STORAGE
L4-02	11.27 m ³		
L4-U3	2.29 m ³	LVL 04	INTERNAL STORAGE
L4-U3	4.90 m ³	B LVL 02	EXTERNAL STORAGE
L4-U3	1.74 m ³	LVL 04	INTERNAL STORAGE
L4-03	8.93 m ³		INTERNAL STORAGE
L4-U4	4.44 m ³	LVL 04	INTERNAL STORAGE
L4-04 L4-04	4.90 m ³	B LVL 02	EXTERNAL STORAGE
L4-04	9.33 m ³	D LVL 02	EXTERNAL STORAGE
15114	9.55 m ²	D 1 1/1 02	
L5-U1	4.90 m ²	B LVL 02	EXTERNAL STORAGE
L5-U1		LVL 05	INTERNAL STORAGE
1.5.110	10.43 m ³	1.1/1 05	
L5-U2	3.22 m ³	LVL 05	INTERNAL STORAGE
15110	3.22 m ³	11/1 05	
L5-U3	2.75 m ³	LVL 05	INTERNAL STORAGE
L5-U3	7.04 m ³	LVL 05	INTERNAL STORAGE
15114	9.79 m ³	11/1 05	
L5-U4	3.45 m ³	LVL 05	INTERNAL STORAGE
L5-U4	4.61 m ³	B LVL 02	EXTERNAL STORAGE
	8.06 m ³		

STORAGE REQUIREMENTS:

1 BED - 6m³ 2 BED - 8m³

3 BED - 10m³

ALL UNITS ACHIEVED MINIMUM STORAGE REQUIREMENTS

	GENERAL NOTES				ISSUE	CLIENT
MORFOSIS ARCHITECTS PTY LTD Suite 8 695 The Horsley Drive, Smithfield NSW 2164 ABN 44 609 593 473 P (02) 8712 5606 / F (02) 8712 5606 / M 0423777623 NOM ARCH J LIGADU NSW ARB NO 8549	OSIS ARCHITECTS PTY LTD 1. ALL DIMENSIONS AND FLOOR AREAS TO BE VERIFIED BUILDIER PRIOR TO THE COMMENCEMENT OF ANY BUILDING WORK. 2. ANY DESCREPANCIESW ARE TO BE CONFIRMEND BY THE DESIGNER. 3. LEVELS SHOWN ARE APPROXIMATE UNLESS ACCOMPANIED BY REDUCED LEVELS BY A REGISTERED SURVEYOR. 4. FIGURED DIMENSIONS AND FLOOR AREAS TO BE TAKEN IN PREFERENCE TO SCALING. 5. LEVELS SHOWN ARE APPROXIMATE UNLESS ACCOMPANIED BY REDUCED LEVELS BY A REGISTERED SURVEYOR. 4. FIGURED DIMENSIONS ARE TO BE TAKEN IN PREFERENCE TO SCALING. 5. LIBOUNDARY CLEARANCE MUST BE VERIFIED BY THE SURVEYOR PRIOR TO THE COMMENCEMENT OF ANY BUILDING WOR 6. WHERE ENGINEERING OR HYDRAULIC DRAWINGS ARE REQUIRED, SUCH MUST TAKE PREFERENCE TO THIS DRAWING. 7. STORMWATER TO BE CONNECTED AND DISCHARGED TO COUNCL'S REQUIREMENTS AND TO AS 3500.3 8. ALL SERVICES TO BE LOCATED AND VERIFIED BY THE BUILDER WITH ERLEVANT AUTHORITIES PRIOR TO THE		DA ISSUE DEP COUNCIL RFI'S RESPONSE DA ISSUE	31/07/24 18/03/24 14/12/23	C	MCKAY MOOREBANK
	SPECIFICATIONS. THEY MUST NOT BE USED, REPRODUCED, OR COPIED IN WHOLE OR IN PART NOR MAY THE INFORMATION, IDEAS AND CONCEPTS THEREIN CONTAINED BE DISCLOSED TO ANY PERSON WITHOUT PRIOR WRITTEN CONSENT OF THE OWNER.	ISSUE	AMENDMENTS	DATE		

SCALE		
@	A3	

DRAWING NUMBER:



DA-403 DRAWING TITLE: STORAGE CALCULATIONS

RESIDENTIAL FLAT BUILDING DEVELOPMENT AT 28 & 30 MCKAY AVENUE MOOREBANK

PROJECT



GROSS FLOOR AREAS


.EVEL	AREA	AFFORDABLE HOUSING AREA
ND FLOOR	407.5 m ²	(407.5 m ²)
01	414.2 m ²	(414.2 m ²)
02	414.2 m ²	(342.7 m ²)
03	414.2 m ²	
04	296.8 m ²	
05	295.5 m²	
06	4.3 m ²	
	2246.6 m ²	(1164.4 m ²)

(1164.4 m²)

AFFORDABLE UNITS SCHEDULE					
Name	Area	Comments			
ROOM ADAPTABLE UNIT	71.3 m ²	AFFORDABLE			
ROOM UNIT	72.5 m ²	AFFORDABLE			
ROOM UNIT	77.2 m²	AFFORDABLE			
ROOM ADAPTABLE UNIT	59.4 m ²	AFFORDABLE			
ROOM UNIT	78.2 m ²	AFFORDABLE			
ROOM UNIT	80.2 m ²	AFFORDABLE			
ROOM UNIT	76.4 m ²	AFFORDABLE			
ROOM UNIT	77.2 m ²	AFFORDABLE			
ROOM ADAPTABLE UNIT	59.4 m ²	AFFORDABLE			
ROOM UNIT	78.2 m ²	AFFORDABLE			
ROOM UNIT	80.2 m ²	AFFORDABLE			
ROOM UNIT	76.4 m ²	AFFORDABLE			
ROOM UNIT	77.2 m²	AFFORDABLE			
ROOM UNIT	78.2 m ²	AFFORDABLE			
ROOM UNIT	59.7 m ²	AFFORDABLE			
	1101 9 m ²	•			


PROJECT


RESIDENTIAL FLAT BUILDING DEVELOPMENT AT 28 & 30 MCKAY AVENUE MOOREBANK

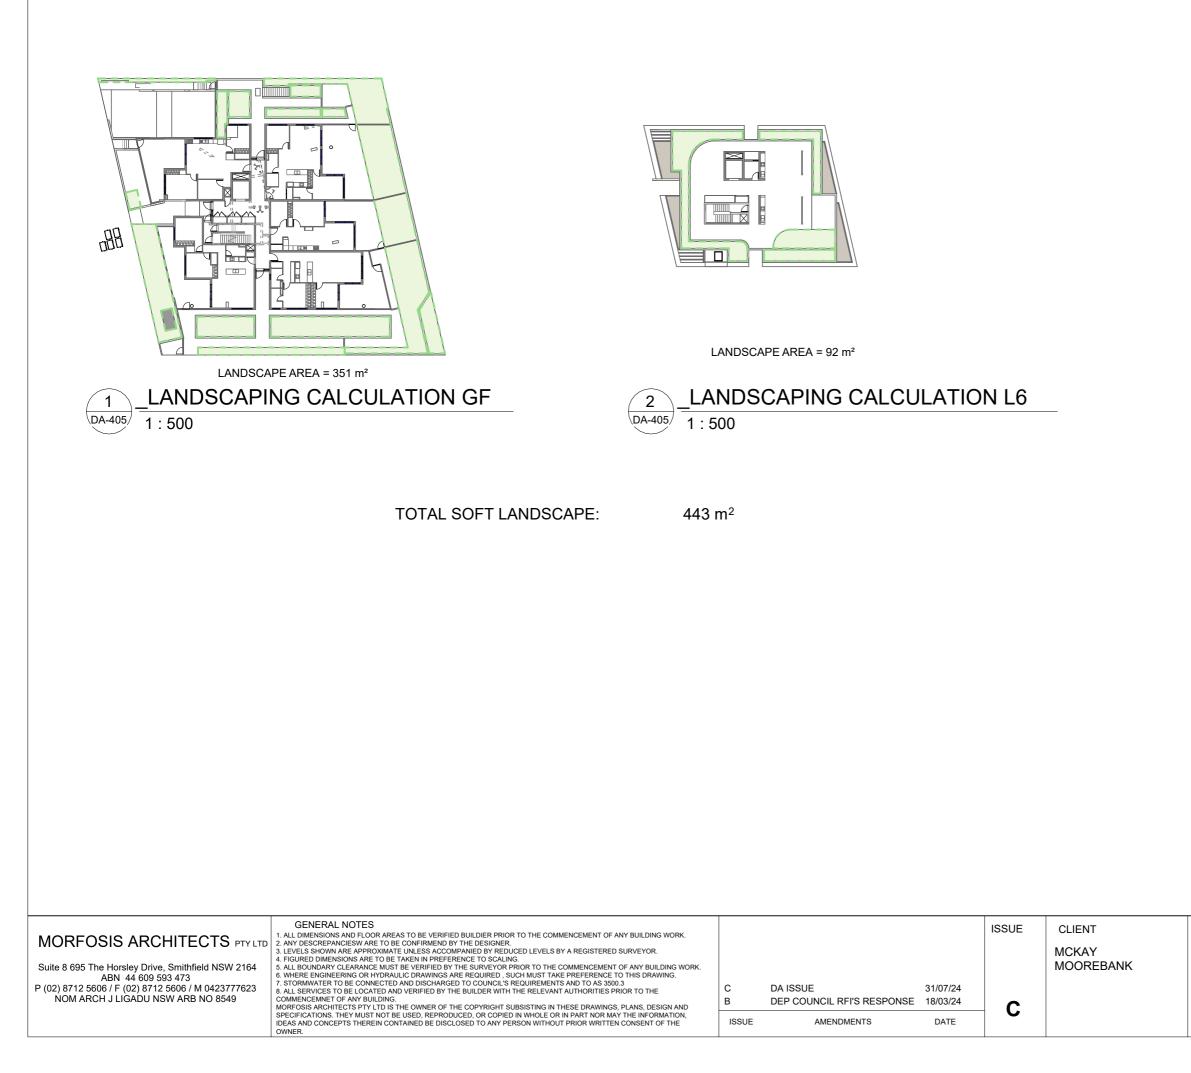

DRAWING NUMBER:	PROJECT
DA-405	
DRAWING TITLE:	RESIDENTIAL FLAT
LANDSCAPE CALCULATIONS	BUILDING
	DEVELOPMENT AT 28 &
	30 MCKAY AVENUE
SCALE	MOOREBANK
1 : 500 @ A3	

DEEP SOIL AREA = 210 m²

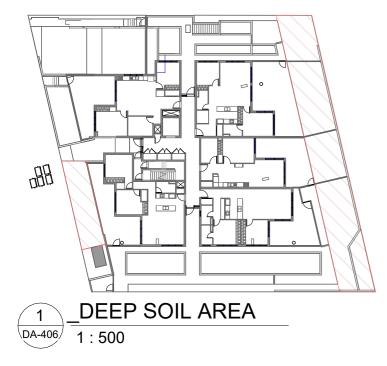

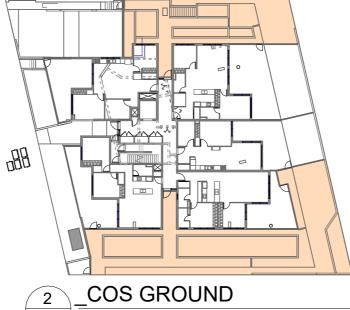

COMMUNAL OPEN SPACE = 412 m²

1:500 DA-406

	UNITS SCHEE	DULE			
Unit	Unit Name Area Comments				Unit
GL-U1	2 BEDROOM ADAPTABLE UNIT	71.3 m ²	AFFORDABLE		GL-U1
GI -U2	2 BEDROOM UNIT	72.5 m ²	AFFORDABLE		GL-U2

GL-U1	2 BEDROOM ADAPTABLE UNIT	71.3 m ²	AFFORDABLE
GL-U2	2 BEDROOM UNIT	72.5 m ²	AFFORDABLE
GL-U3	2 BEDROOM UNIT	77.2 m ²	AFFORDABLE
GL-U4	1 BEDROOM ADAPTABLE UNIT	59.4 m ²	AFFORDABLE
GL-U5	2 BEDROOM UNIT	78.2 m ²	AFFORDABLE
L1-U1	2 BEDROOM UNIT	80.2 m ²	AFFORDABLE
L1-U2	2 BEDROOM UNIT	76.4 m ²	AFFORDABLE
L1-U3	2 BEDROOM UNIT	77.2 m ²	AFFORDABLE
L1-U4	1 BEDROOM ADAPTABLE UNIT	59.4 m ²	AFFORDABLE
L1-U5	2 BEDROOM UNIT	78.2 m ²	AFFORDABLE
L2-U1	2 BEDROOM UNIT	80.2 m ²	AFFORDABLE
L2-U2	2 BEDROOM UNIT	76.4 m ²	AFFORDABLE
L2-U3	2 BEDROOM UNIT	77.2 m ²	AFFORDABLE
L2-U4	1 BEDROOM UNIT	59.7 m ²	
L2-U5	2 BEDROOM UNIT	78.2 m ²	AFFORDABLE
L3-U1	2 BEDROOM UNIT	80.2 m ²	
L3-U2	2 BEDROOM UNIT	76.4 m ²	
L3-U3	2 BEDROOM UNIT	77.2 m ²	
L3-U4	1 BEDROOM UNIT	59.7 m ²	AFFORDABLE
L3-U5	2 BEDROOM UNIT	78.2 m ²	
L4-U1	1 BEDROOM UNIT	56.3 m ²	
L4-U2	1 BEDROOM UNIT	51.2 m ²	
L4-U3	2 BEDROOM UNIT	75.7 m ²	
L4-U4	2 BEDROOM UNIT	75.3 m ²	
L5-U1	1 BEDROOM UNIT	55.8 m ²	
L5-U2	1 BEDROOM UNIT	51.3 m ²	
L5-U3	3 BEDROOM UNIT	98.2 m ²	
L5-U4	1 BEDROOM UNIT	50.3 m ²	
28			

TOTAL SITE AREA :	1365.8 SQM			
-MAX F.S.R ALLOWED	: 1.2:1 + BONUS 0.5			
(UNDER LIVERPOOL LEP + AFH SEPP 2021) : 1.7:1				
-GROSS FLOOR AREA ALLOWED (LLE	P) : 1.7 X 1365.8 = 2321.86 SQM			
-PROPOSED GROSS FLOOR AREA	: <u>2247 SQM</u>			
-PROPOSED FLOOR RATIO	: <u>1.65:1</u>			
LANDSCAPING AREA (REQUIRED) LANDSCAPING AREA (PROPOSED)	: 409.74 SQM (30%) : 459.00 SQM (34%)			
DEEP SOIL AREA (REQUIRED) DEEP SOIL AREA (PROPOSED)	: 204.87 SQM (15%) : 210.01 SQM (15.38%)			
COMMUNAL OPEN SPACE (REQUIRED COMMUNAL OPEN SPACE (PROPOSEI	 2) : 341.45 SQM (25%) 2) : 607 SQM (44%) 			
UNIT	S MIX			
TYPE	QUANTITY			
2 BEDROOM	18 UNITS			
2 BEDROOM ADAPTABLE	1 UNIT			
1 BEDROOM	6 UNITS			
1 BEDROOM ADAPTABLE	2 UNITS			
3 BEDROOM 1 UNITS				
TOTAL	28 UNITS			

DEVELOPMENT SUMMARY

TOTAL ADAPTABLE UNITS		
10% OF TOTAL 28 UNITS = 2.8 =	3 UNITS REQUIRED	
TYPE	TOTAL (TYPE)	
2 BEDROOM ADAPTABLE	1 UNIT (TYPE A)	
1 BEDROOM ADAPTABLE	2 UNITS (TYPE B)	
TOTAL	3 UNITS PROVIDED	
TOTAL AFFC	ORDABLE UNITS	
AFFORDABLE HOUSING AREA REC	QUIRED (AFH SEPP 2021)	
50% OF TOTAL GFA = 1160.9 SQM	1	
	-	
AFFORDABLE HOUSING AREA PRO	OVIDED (AFH SEPP 2021) : 1164.4 S	
TOTAL 15 UNITS PROVIDED AS A	FFORDABLE	
TYPE	TOTAL (TYPE)	
2 BEDROOM	11 UNITS	
2 BEDROOM ADAPTABLE	1 UNIT	
1 BEDROOM	1 UNITS	
1 BEDROOM ADAPTABLE	2 UNITS	
TOTAL	15 UNITS	
PARKING CALCULA	TIONS - AFH SEPP 2021	
	8 × 0.5 = 4 CAPS	

PARKING CALCULATIONS - AFH SEPP 2021					
	1 BED (0.5 CAR)	8 x 0.5 = 4 CARS			
	2 BED (1 CAR) 3 BED (1.5 CAR)	19 x 1 = 19 CARS 1 x 1.5 = 1.5 CARS			
	TOTAL CARS (REQUIRED)	25 CARS			
	TOTAL CARS (PROVIDED)	32 CARS			

	GENERAL NOTES				ISSUE	CLIENT	DRAWING
MORFOSIS ARCHITECTS PTYLTD	 ALL DIMENSIONS AND FLOOR AREAS TO BE VERIFIED BUILDIER PRIOR TO THE COMMENCEMENT OF ANY BUILDING WORK. ANY DESCREPANCIESW ARE TO BE CONFIRMEND BY THE DESIGNER. 				ICCOL		DA-406
	 LEVELS SHOWN ARE APPROXIMATE UNLESS ACCOMPANIED BY REDUCED LEVELS BY A REGISTERED SURVEYOR. FIGURED DIMENSIONS ARE TO BE TAKEN IN PREFERENCE TO SCALING. 					MCKAY	
Suite 8 695 The Horsley Drive, Smithfield NSW 2164 ABN 44 609 593 473	 ALL BOUNDARY CLEARANCE MUST BE VERIFIED BY THE SURVEYOR PRIOR TO THE COMMENCEMENT OF ANY BUILDING WORK. WHERE ENGINEERING OR HYDRAULIC DRAWINGS ARE REQUIRED, SUCH MUST TAKE PREPERENCE TO THIS DRAWING. 	с	DA ISSUE	31/07/24		MOOREBANK	DEVEL CALCU
P (02) 8712 5606 / F (02) 8712 5606 / M 0423777623	 STORMWATER TO BE CONNECTED AND DISCHARGED TO COUNCIL'S REQUIREMENTS AND TO AS 3500.3 ALL SERVICES TO BE LOCATED AND VERIFIED BY THE BUILDER WITH THE RELEVANT AUTHORITIES PRIOR TO THE 	В	DEP COUNCIL RFI'S RESPONSE	18/03/24			
NOM ARCH J LIGADU NSW ARB NO 8549	COMMENCEMNET OF ANY BUILDING. MORFOSIS ARCHITECTS PTY LTD IS THE OWNER OF THE COPYRIGHT SUBSISTING IN THESE DRAWINGS, PLANS, DESIGN AND	A	DA ISSUE	14/12/23	C		SCALE
	SPECIFICATIONS. THEY MUST NOT BE USED, REPRODUCED, OR COPIED IN WHOLE OR IN PART NOR MAY THE INFORMATION, IDEAS AND CONCEPTS THEREIN CONTAINED BE DISCLOSED TO ANY PERSON WITHOUT PRIOR WRITTEN CONSENT OF THE OWNER.	ISSUE	AMENDMENTS	DATE			As indi

3 DA-406 1 : 500

COMMUNAL OPEN SPACE = 194 m²



COS LVL 6

AFFORDABLE UNITS SCHEDULE						
Unit	Name	Area	Comments			
GL-U1	2 BEDROOM ADAPTABLE UNIT	71.3 m ²	AFFORDABLE			
GL-U2	2 BEDROOM UNIT	72.5 m ²	AFFORDABLE			
GL-U3	2 BEDROOM UNIT	77.2 m ²	AFFORDABLE			
GL-U4	1 BEDROOM ADAPTABLE UNIT	59.4 m ²	AFFORDABLE			
GL-U5	2 BEDROOM UNIT	78.2 m ²	AFFORDABLE			
L1-U1	2 BEDROOM UNIT	80.2 m ²	AFFORDABLE			
L1-U2	2 BEDROOM UNIT	76.4 m ²	AFFORDABLE			
L1-U3	2 BEDROOM UNIT	77.2 m ²	AFFORDABLE			
L1-U4	1 BEDROOM ADAPTABLE UNIT	59.4 m ²	AFFORDABLE			
L1-U5	2 BEDROOM UNIT	78.2 m ²	AFFORDABLE			
L2-U1	2 BEDROOM UNIT	80.2 m ²	AFFORDABLE			
L2-U2	2 BEDROOM UNIT	76.4 m ²	AFFORDABLE			
L2-U3	2 BEDROOM UNIT	77.2 m ²	AFFORDABLE			
L2-U5	2 BEDROOM UNIT	78.2 m ²	AFFORDABLE			
L3-U4	1 BEDROOM UNIT	59.7 m ²	AFFORDABLE			
15		1101.9 m ²				

DA-406 DRAWING TITLE: DEVELOPMENT CALCULATIONS SCALE As indicated @ A3	\bigcirc	PROJECT RESIDENTIAL FLAT BUILDING DEVELOPMENT AT 28 & 30 MCKAY AVENUE MOOREBANK
DRAWING NUMBER:		PROJECT
		RESIDENTIAL FLAT
CALCULATIONS	t	
SCALE		
As indicated @ A3	T	

		Sliding Doo	r Schedule		
UNIT	Mark	Level	Height	Width	HH
GL-U1	SD01	GF LVL	2700	2700	2700
GL-U2	SD01	GF LVL	2700	3000	2700
01.110	0004	0511	0700	0000	0700
GL-U3	SD01	GF LVL	2700	2000	2700
GL-U3	SD02	GF LVL	2700	2000	2700
GL-U4	8001		2700	2000	2700
	SD01	GF LVL GF LVL	2700	2000	2700
GL-U4	SD02	GF LVL	2700	2400	2700
GL-U5	8001	GF LVL	2700	2000	2700
	SD01	-	2700	2000	2700
GL-U5	SD02	GF LVL	2700	2000	2700
GL-U5	SD03	GF LVL	2700	2100	2700
L1-U1	SD01	LVL 01	2800	3800	2800
L1-U2	SD01	LVL 01	2700	3000	2700
L1-U3	SD01	LVL 01	2700	2000	2700
L1-U3	SD02	LVL 01	2700	2700	2700
L1-U4	SD01	LVL 01	2700	2000	2700
L1-U4	SD02	LVL 01	2700	2000	2700
L1-U5	SD01	LVL 01	2700	2000	2700
L1-U5	SD02	LVL 01	2700	3000	2700
		-			
L2-U1	SD01	LVL 02	2800	4000	2800
L2-U2	SD01	LVL 02	2700	3000	2700
10110	0001	11/1 00	0700	0000	0700
L2-U3	SD01	LVL 02	2700	2000	2700
L2-U3	SD02	LVL 02	2700	2700	2700
10114	0004	1.1/1 00	0700	2000	0700
L2-U4	SD01	LVL 02	2700	2000	2700
L2-U4	SD02	LVL 02	2700	2000	2700
10115	0004	11/1 00	0700	2000	0700
L2-U5	SD01	LVL 02	2700	2000	2700
L2-U5	SD02	LVL 02	2700	3000	2700
L3-U1	SD01	LVL 03	2800	3800	2800
	10001	1212 00	2000	0000	2000
L3-U2	SD01	LVL 03	2700	3000	2700
L3-U3	SD01	LVL 03	2700	2000	2700
L3-U3	SD02	LVL 03	2700	2700	2700
	05.5	1.1.4			
L3-U4	SD01	LVL 03	2700	2000	2700
L3-U4	SD02	LVL 03	2700	2000	2700
	0.000	1.1.4	lanas		
L3-U5	SD01	LVL 03	2700	2000	2700
L3-U5	SD02	LVL 03	2700	3000	2700
	0551	1.1.11 - 1	0700	0400	0-0
L4-U1	SD01	LVL 04	2700	2100	2700
14112	8004	11/1 04	2700	2000	2700
L4-U2	SD01	LVL 04	2700	2000	2700
L4-U2	SD02	LVL 04	2700	2000	2700
1 1 1 12	SD01		2700	2000	2700
L4-U3	SD01	LVL 04	2700	2000	2700
L4-U3	SD02	LVL 04	2700	2100	2700
1 4 1 1 4	8004	1.1/1 04	2700	1000	0700
L4-U4	SD01	LVL 04	2700	1800	2700
L4-U4	SD02	LVL 04	2700	3100	2700
L4-U4	SD03	LVL 04	2700	2285	2700
L5-U1	SD01	LVL 05	2700	2100	2700
L5-U2	SD01	LVL 05	2700	2000	2700
L5-U2	SD02	LVL 05	2700	2000	2700
	05.5	1.1.4			
L5-U3	SD01	LVL 05	2700	2700	2700
L5-U3	SD02	LVL 05	2800	3600	2800
				_	
L5-U4	SD01	LVL 05	2700	2000	2700

Window Schedule						
Comments	Mark	Level	Height	Width	HH	Туре
Common-G	W01	GF LVL	2600	700	2700	FW + SIDE GLASS LOUVRES
Common-G	W02	GF LVL	2600	700	2700	FW + SIDE GLASS LOUVRES
Common-G	W03	GF LVL	2600	700	2700	FW + SIDE GLASS LOUVRES
Common-L1	W04	LVL 01	2600	1385	2700	FW + SIDE GLASS LOUVRES
Common-L1	W05	LVL 01	2600	1200	2700	FW + SIDE GLASS
Common-L1	W06	LVL 01	2600	1200	2700	FW + SIDE GLASS LOUVRES
Common-L2	W07	LVL 02	2600	1385	2700	FW + SIDE GLASS LOUVRES
Common-L2	W08	LVL 02	2600	1200	2700	FW + SIDE GLASS
Common-L2	W09	LVL 02	2600	1200	2700	FW + SIDE GLASS LOUVRES
Common-L3	W10	LVL 03	2600	1385	2700	FW + SIDE GLASS
Common-L3	W11	LVL 03	2600	1200	2700	LOUVRES FW + SIDE GLASS
Common-L3	W12	LVL 03	2600	1200	2700	LOUVRES FW + SIDE GLASS LOUVRES
Common-L4	W13	LVL 04	2600	1385	2700	FW + SIDE GLASS
Common-L4	W14	LVL 04	2600	1200	2700	LOUVRES FW + SIDE GLASS
Common-L4	W15	LVL 04	2600	1200	2700	LOUVRES FW + SIDE GLASS
Common-L5	W16	LVL 05	2600	4205	2700	FW + SIDE GLASS
Common-L5	W10	LVL 05	2600	1385	2700	LOUVRES
Common-L5	W17	LVL 05	2600	1200	2700	LOUVRES
Common-Lo	WIG		2000	1200	2700	LOUVRES
Common-L6	W19	LVL 06	700	640	2500	AWNING
GL-U1	W01	GF LVL	700	2400	2500	SLIDING 3-PANELS
GL-U1	W02	GF LVL	700	2400	1600	SLIDING 3-PANELS
GL-U1	W03	GF LVL	2600	2600	2700	FH SLIDING 3-PANELS
GL-U2	W01	GF LVL	2600	1800	2700	FH AWNING 2-PANELS
GL-U2	W02	GF LVL	2600	2700	2700	FH SLIDING 3-PANELS
GL-U2	W03	GF LVL	700	2700	2500	SLIDING 3-PANELS
GL-U3	W01	GF LVL	700	1000	2500	AWNING
GL-U3	W02	GF LVL	700	2700	2500	SLIDING 3-PANELS
GL-U3 GL-U3	W03 W04	GF LVL GF LVL	700	2700	2500 2700	SLIDING 3-PANELS FH SLIDING
GL-U3	W04	GF LVL GF LVL	2600	3000	2700	3-PANELS AWNING
02.00			100	100	2000	1
GL-U4	W01	GF LVL	2600	3000	2700	FH SLIDING 3-PANELS
GL-U5	W01	GF LVL	2600	2600	2700	FH SLIDING 3-PANELS
GL-U5	W02	GF LVL	700	2400	2500	SLIDING 3-PANELS
GL-U5	W03	GF LVL	700	2400	2500	SLIDING 3-PANELS
L1-U1	W01	LVL 01	1500	2400	2500	SLIDING 3-PANELS
L1-U1	W02	LVL 01	700	2400	2500	SLIDING 3-PANELS
L1-U1	W03	LVL 01	2600	2600	2700 2500	FH SLIDING 3-PANELS AWNING
L1-U1	W04	LVL 01	700	700	2500	AWNING
L1-U1	W06	LVL 01	700	2400	2500	SLIDING 3-PANELS

Comments	Mark	Level	Height	Width	HH	Туре	Comme
		1					
L1-U2	W01	LVL 01	2600	1800	2800	FH AWNING 2-PANELS	L3-U3 L3-U3
L1-U2	W02	LVL 01	2600	2700	2700	FH SLIDING 3-PANELS	L3-U3
L1-U2	W03	LVL 01	700	2700	2500	SLIDING 3-PANELS	L3-U4
L1-U2	W04	LVL 01	700	700	2500	AWNING	23-04
L1-U3	W01	LVL 01	700	1000	2500	AWNING	L3-U5
L1-U3	W02	LVL 01	1500	2700	2500	SLIDING 3-PANELS	
L1-U3	W03	LVL 01	700	2700	2500	SLIDING 3-PANELS	L3-U5
L1-U3	W04	LVL 01	2600	3000	2700	FH SLIDING 3-PANELS	L3-U5 L3-U5
L1-U3	W05	LVL 01	700	700	2500	AWNING	L3-U5
L1-U4	W01	LVL 01	2600	3000	2700	FH SLIDING	L4-U1
L1-04	10001		2000	3000	2700	3-PANELS	L4-01 L4-U1
							L4-U1
L1-U5	W01	LVL 01	2600	2600	2700	FH SLIDING 3-PANELS	L4-U1
L1-U5	W02	LVL 01	700	2400	2500	SLIDING 3-PANELS	L4-01
L1-U5	W03	LVL 01	1500	2400	2500	SLIDING 3-PANELS	
L1-U5	W04	LVL 01	700	2400	2500	SLIDING 3-PANELS	L4-U2
L1-U5	W05	LVL 01	700	700	2500	AWNING	L4-U2
L2-U1	W01	LVL 02	1500	2400	2500	SLIDING 3-PANELS	L4-02 L4-U2
L2-U1	W02	LVL 02	700	2400	2500	SLIDING 3-PANELS	24 02
L2-U1	W03	LVL 02	2600	2600	2700	FH SLIDING 3-PANELS	L4-U2
L2-U1	W04	LVL 02	700	700	2500	AWNING	L4-U2
L2-U1	W05	LVL 02	700	700	2500	AWNING	
L2-U1	W06	LVL 02	700	2400	2500	SLIDING 3-PANELS	L4-U3
				_	_		L4-U3
L2-U2	W01	LVL 02	2600	1800	2800	FH AWNING 2-PANELS	L4-U3 L4-U3
L2-U2	W02	LVL 02	2600	2700	2700	FH SLIDING 3-PANELS	
L2-U2	W03	LVL 02	700	2700	2500	SLIDING 3-PANELS	L4-U4
L2-U2	W04	LVL 02	700	700	2500	AWNING	L4-U4
L2-U3	W01	LVL 02	700	1000	2500	AWNING	L4-U4
L2-U3	W01	LVL 02	1500	2700	2500	SLIDING 3-PANELS	
L2-U3	W03	LVL 02	700	2700	2500	SLIDING 3-PANELS	L5-U1
L2-U3	W04	LVL 02	2600	3000	2700	FH SLIDING 3-PANELS	L5-U1 L5-U1
L2-U3	W05	LVL 02	700	700	2500	AWNING	
				1	1		L5-U1
L2-U4	W01	LVL 02	2600	3000	2700	FH SLIDING 3-PANELS	L5-U1
	-						L5-U2
L2-U5	W01	LVL 02	2600	2600	2700	FH SLIDING 3-PANELS	L5-U2
L2-U5	W02	LVL 02	700	2400	2500	SLIDING 3-PANELS	L5-U2
L2-U5	W03	LVL 02	1500	2400	2500	SLIDING 3-PANELS	
L2-U5	W04	LVL 02	700	2400	2500	SLIDING 3-PANELS	L5-U2
L2-U5	W05	LVL 02	700	700	2500	AWNING	L5-U2
L3-U1	W01	LVL 03	1500	2400	2500	SLIDING 3-PANELS	
L3-U1	W02	LVL 03	700	2400	2500	SLIDING 3-PANELS	L5-U3
L3-U1	W03	LVL 03	2600	2600	2700	FH SLIDING	L5-U3
L3-U1	W04	LVL 03	700	700	2500	3-PANELS AWNING	L5-U3 L5-U3
L3-U1	W05	LVL 03	700	700	2500	AWNING	
L3-U1	W06	LVL 03	700	2400	2500	SLIDING 3-PANELS	L5-U3
L3-U2	W01	LVL 03	2600	2600	2700	FH SLIDING	
L3-U2	W02	LVL 03	2600	2700	2700	3-PANELS FH SLIDING	L5-U4
						3-PANELS	SK-
L3-U2	W03	LVL 03	700	2700	2500	SLIDING 3-PANELS	SK-
L3-U2	W04	LVL 03	700	700	2500	AWNING	
L3-U3	W01	LVL 03	700	1000	2500	AWNING	

Suite 8 695 The Horsley Drive, Smithfield NSW 2164 ABN 44 609 593 473 P (02) 8712 5606 / F (02) 8712 5606 / M 0423777623 NOM ARCH J LIGADU NSW ARB NO 8549

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7. STORMWATER TO BE CONNECTED AND DISCHARGED TO COUNCIL'S REQUIREMENTS AND TO AS 3500.3
8. ALL SERVICES TO BE LOCATED AND VERIFIED BY THE BUILDER WITH THE RELEVANT AUTHORITIES PRIOR TO THE COMMENCEMENT OF ANY BUILDING.
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			ISSUE	CLIENT
С	DA ISSUE	31/07/24		MCKAY MOOREBANK
В	DEP COUNCIL RFI'S RESPONSE	18/03/24		
Α	DA ISSUE	14/12/23	С	
ISSUE	AMENDMENTS	DATE		

SCALE @ A3



PROJECT


RESIDENTIAL FLAT BUILDING DEVELOPMENT AT 28 & 30 MCKAY AVENUE MOOREBANK

DRAWING TITLE: WINDOW SCHEDULE

DRAWING NUMBER:	
DA-407	

Comments	Mark	Level	Height	Width	HH	Туре
_3-U3	W03	LVL 03	700	2700	2500	SLIDING 3-PANEL
_3-U3	W04	LVL 03	2600	3000	2700	FH SLIDING 3-PANELS
_3-U3	W05	LVL 03	700	700	2500	AWNING
.3-U4	W01	LVL 03	2600	3000	2700	FH SLIDING
	1001		2000	3000	2700	3-PANELS
_3-U5	W01	LVL 03	2600	2600	2700	FH SLIDING
0.115	14/00			0.400	0500	3-PANELS
_3-U5 _3-U5	W02 W03	LVL 03 LVL 03	700	2400 2400	2500 2500	SLIDING 3-PANEL SLIDING 3-PANEL
_3-05 _3-05	W03	LVL 03	700	2400	2500	SLIDING 3-PANEL
L3-U5	W05	LVL 03	700	700	2500	AWNING
				1		
_4-U1	W01	LVL 04	1900	900	2100	BOXED AWNING
_4-U1	W02	LVL 04	1500	3000	2500	SLIDING 3-PANEL
_4-U1	W03	LVL 04	2600	2600	2700	FH SLIDING 3-PANELS
_4-U1	W04	LVL 04	700	640	2500	AWNING
_4-U1	W05	LVL 04	700	2400	2500	SLIDING 3-PANEL
_4-U2	W01	LVL 04	2600	2600	2700	FH SLIDING
_		-				3-PANELS
_4-U2	W02	LVL 04	1900	900	2100	BOXED AWNING
_4-U2	W03	LVL 04	1500	2000	2500	FH AWNING 2-PANELS
_4-U2	W04	LVL 04	1500	2000	2500	FH AWNING
_4-U2	W05	LVL 04	700	640	2500	2-PANELS AWNING
14 02	1100	212 04	100	040	2000	
_4-U3	W01	LVL 04	1500	2700	2500	SLIDING 3-PANEL
L4-U3	W02	LVL 04	1900	900	2100	BOXED AWNING
_4-U3	W03	LVL 04	700	2700	2500	SLIDING 3-PANEL
_4-U3	W04	LVL 04	2600	3000	2700	FH AWNING 3-PANELS
_4-U4	W01	LVL 04	2600	2000	2700	FH AWNING 2-PANELS
L4-U4	W02	LVL 04	1500	2400	2500	SLIDING 3-PANEL
_4-U4	W03	LVL 04	700	700	2500	AWNING
5.114	14/01	11/1 05	1000	900	2100	
L5-U1 L5-U1	W01 W02	LVL 05 LVL 05	1900	3000	2100 2500	BOXED AWNING SLIDING 3-PANEL
L5-U1	W02	LVL 05	2600	2600	2700	FH SLIDING
						3-PANELS
_5-U1	W04	LVL 05	700	640	2500	AWNING
L5-U1	W05	LVL 05	700	2400	2500	SLIDING 3-PANEL
_5-U2	W01	LVL 05	2600	2600	2700	FH SLIDING
						3-PANELS
_5-U2	W02	LVL 05	1900	900	2100	BOXED AWNING
_5-U2	W03	LVL 05	1500	2000	2500	FH AWNING 2-PANELS
L5-U2	W04	LVL 05	1500	2000	2500	FH AWNING
						2-PANELS
L5-U2	W05	LVL 05	700	640	2500	AWNING
_5-U3	W01	LVL 05	1500	2700	2500	SLIDING 3-PANEL
_5-U3	W02	LVL 05	1900	900	2100	BOXED AWNING
L5-U3	W03	LVL 05	700	2700	2500	SLIDING 3-PANEL
_5-U3	W04	LVL 05	2600	2025	2800	FH AWNING
L5-U3	W05	LVL 05	2600	2000	2700	2-PANELS FH AWNING
20.00	1103		2000	2000	2100	2-PANELS
5.14	W01	11/1 05	1500	2000	2500	
L5-U4	W01	LVL 05	1500	3000	2500	SLIDING 3-PANEL
	SK-01	LVL 04	1200	1000		1200x1000
SK-						

Window Schedule

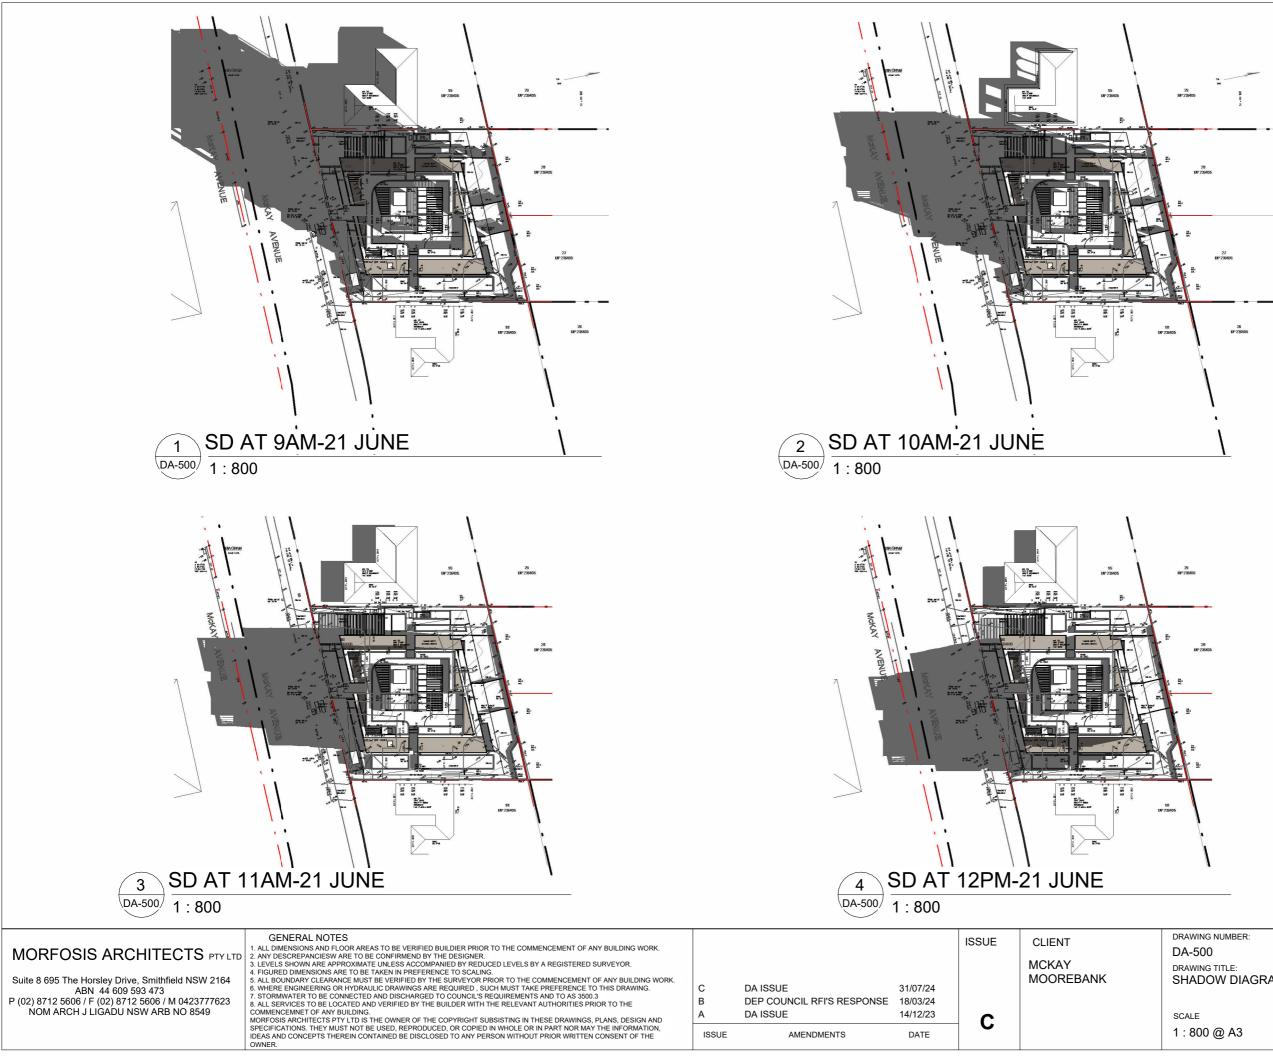

C B A	DA ISSUE DEP COUNCIL RFI'S RESPONSE DA ISSUE	31/07/24 18/03/24 14/12/23	С	
ISSUE	AMENDMENTS	DATE		


SCALE 1 : 800 @ A3



SHADOW DIAGRAMS STUDY

RESIDENTIAL FLAT BUILDING DEVELOPMENT AT 28 & 30 MCKAY AVENUE MOOREBANK

PROJECT

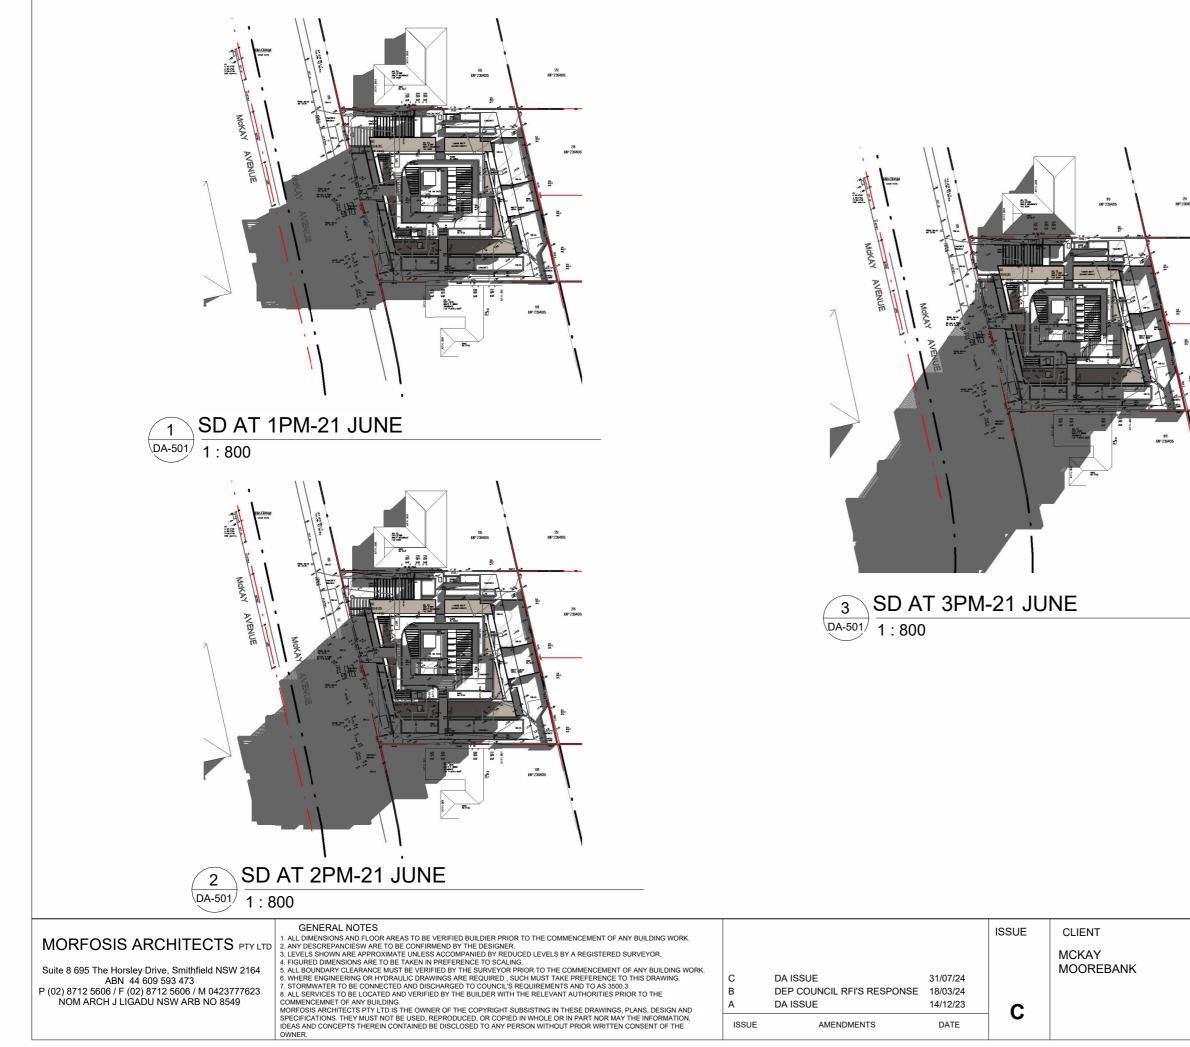

ISSUE

AMENDMENTS

DATE

DRAWING NUMBER:	PROJECT
DA-501	
DRAWING TITLE: SOLAR ACCESS AT 1 PM - 3 PM	RESIDENTIAL FLAT BUILDING DEVELOPMENT AT 28 & 30 MCKAY AVENUE
SCALE 1 : 800 @ A3	MOOREBANK





Suite 8 695 The Horsley Drive, Smithfield NSW 2164 ABN 44 609 593 473 P (02) 8712 5606 / F (02) 8712 5606 / M 0423777623 NOM ARCH J LIGADU NSW ARB NO 8549

GENERAL NOTES

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ISSUE CLIENT DRAWING NU DA-600
MCKAY DRAWING TI MOOREBANK 3D VIEW
C DA ISSUE 31/07/24 B DEP COUNCIL RFI'S RESPONSE 18/03/24 C SCALE
ISSUE AMENDMENTS DATE @A3

DA-600 DRAWING TITLE: 3D VIEW- FUTURE SETTIING PROJECT

BUILDING

RESIDENTIAL FLAT

DEVELOPMENT AT 28 & 30 MCKAY AVENUE MOOREBANK



MORFOSIS ARCHITECTS PTVTD GENERAL NOTES PROJECT DRAWING NUMBER: PROJECT DA-601 DA-601 <t< th=""></t<>
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Suite 8 695 The Horsley Drive, Smithfield NSW 2164 ABN 44 609 593 473 P (02) 8712 5606 / F (02) 8712 5606 / M 0423777623 NOM ARCH J LIGADU NSW ARB NO 8549

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			ISSUE	CLIENT MCKAY MOOREBANK	DRAWING NUMBER: DA-602 DRAWING TITLE: 3D VIEW- FUT
с	DA ISSUE	31/07/24			
В	DEP COUNCIL RFI'S RESPONSE	18/03/24	С		SCALE
ISSUE	AMENDMENTS	DATE			@ A3

SCALE					
@	A3				

DA-602 DRAWING TITLE: 3D VIEW- FUTURE SETTIING

PROJECT

BUILDING

RESIDENTIAL FLAT

DEVELOPMENT AT 28 & 30 MCKAY AVENUE MOOREBANK



Suite 8 695 The Horsley Drive, Smithfield NSW 2164 ABN 44 609 593 473 P (02) 8712 5606 / F (02) 8712 5606 / M 0423777623 NOM ARCH J LIGADU NSW ARB NO 8549

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			ISSUE	CLIENT MCKAY MOOREBANK	DRAWING NUMBER: DA-603 DRAWING TITLE: 3D VIEW- FUT
C B	DA ISSUE DEP COUNCIL RFI'S RESPONSE	31/07/24 18/03/24	С		SCALE
ISSUE	AMENDMENTS	DATE			@ A3

DA-603 DRAWING TITLE: 3D VIEW- FUTURE SETTIING

PROJECT

BUILDING

RESIDENTIAL FLAT

DEVELOPMENT AT 28 & 30 MCKAY AVENUE MOOREBANK



MORFOSIS ARCHITECTS PTY LTD Suite 8 695 The Horsley Drive, Smithfield NSW 2164 ABN 44 609 593 473 P (02) 8712 5606 / F (02) 8712 5606 / M 0423777623 NOM ARCH J LIGADU NSW ARB NO 8549	GENERAL INCITES 1. ALL DIMENSIONS AND FLOOR AREAS TO BE VERIFIED BUILDIER PRIOR TO THE COMMENCEMENT OF ANY BUILDING WORK. 2. ANY DESCREPANCIESW ARE TO BE CONFIRMEND BY THE DESIGNER. 3. LEVELS SHOWN ARE APPROXIMATE UNLESS ACCOMPANIED BY REDUCED LEVELS BY A REGISTERED SURVEYOR. 4. FIGURED DIMENSIONS ARE TO BE TAKEN IN PREFERENCE TO SCALING. 5. ALL BOUNDARY CLEARANCE MUST BE VERIFIED BY THE SURVEYOR PRIOR TO THE COMMENCEMENT OF ANY BUILDING WORK. 6. WHERE ENGINEERING OR HYDRAULIC DRAWINGS ARE REQUIRED, SUCH MUST TAKE PREFERENCE TO THIS DRAWING. 7. STORMWATER TO BE CONNECTED AND DISCHARGED TO COUNCIL'S REQUIREMENTS AND TO AS 3500.3 8. ALL SERVICES TO BE LOCATED AND VERIFIED BY THE BUILDER WITH THE RELEVANT AUTHORITIES PRIOR TO THE COMMENCEMNET OF ANY BUILDING. MORFOSIS ARCHITECTS PTY LTD IS THE OWNER OF THE COPYRIGHT SUBSISTING IN THESE DRAWINGS, PLANS, DESIGN AND SPECIFICATIONS. THEY MUST NOT BE USED, REPODUCED, OR COPIED IN WHOLE OR IN PART NOR MAY THE INFORMATION, IDEAS AND CONCEPTS THEREIN CONTAINED BE DISCLOSED TO ANY PERSON WITHOUT PRIOR WRITTEN CONSENT OF THE OWNER	C B ISSUE	DA ISSUE DEP COUNCIL RFI'S RESPONSE AMENDMENTS	31/07/24 18/03/24 DATE	- C	CLIENT MCKAY MOOREBANK
	OWNER.					

SCALE @ A3

DA-604 DRAWING TITLE: 3D VIEW - FUTURE SETTIING

PROJECT

RESIDENTIAL FLAT BUILDING DEVELOPMENT AT 28 & 30 MCKAY AVENUE MOOREBANK